

### **ACTIVITY DETERMINATION**

Project No. BGZEE

Conflict	of	Interest <sup>1</sup>

In this matter:

- 1. I have declared any possible conflict of interests (real, potential or perceived) to the Acting Head of Housing Portfolio, Homes NSW.
- 2. I do not consider I have any personal interests that would affect my professional judgement.
- 3. I will inform the Acting Head of Housing Portfolio, Homes NSW as soon as I become aware of a possible conflict of interest.

Signed Da
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Yolanda Gil

Acting Executive Director, Portfolio Strategy and Origination

Housing Portfolio

Homes NSW

Having regard to the Determination Recommendation Report, the Statement of Compliance and the Review of Environmental Factors for this project addressing matters under Part 5 of the *Environmental Planning and Assessment Act 1979*, I determine that the activity proceed as described below and subject to the identified requirements set out in **Schedule 1**.

SITE IDENTIFICATION	
STREET ADDRESS	
Unit/Street No	Street or property name
10 - 14 and 5	Munmurra Road and Bernadotte Street
Suburb, town or locality	Postcode
Riverwood	2210
Local Government Area(s)	Real property description (Lot and DP)
Georges River	Lots 57, 58, 59 and 60 in Deposited Plan 35818

### **ACTIVITY DESCRIPTION**

Removal of trees, and the construction of 16 seniors housing units comprising  $8 \times 1$  bedroom and  $8 \times 2$  bedroom units, with associated landscaping and fencing, surface parking for 12 cars, and consolidation into a single lot.

Conflict of interest includes actual and potential. A conflict of interest includes pecuniary i.e. financial interests to you or a related party or non-pecuniary i.e. benefits to relatives, friends, business associates and personal causes, etc. This includes "related persons" as defined in the Property, Stock and Business Agency Act 2002.

Signed......

Dated......

Yolanda Gil Acting Executive Director, Portfolio Strategy and Origination Housing Portfolio Homes NSW

### **SCHEDULE 1**

### **IDENTIFIED REQUIREMENTS**

### PART A – Standard Identified Requirements

#### THE DEVELOPMENT

The following identified requirements are to ensure that the residential activity is carried out in accordance with the plans / documents and any amendments arising from the Review of Environmental Factors under Part 5 of the Environmental Planning & Assessment Act 1979, Section 171 of the Environmental Planning and Assessment Regulation 2021 and the requirements of State Environmental Planning Policy (Housing) 2021.

1. The development shall be carried out substantially in accordance with the following plans / documents as modified below and by any of the undermentioned identified requirements:

Title / Name:	Drawing No. / Document Ref	Revision / Issue:	Date [dd/mm/yyyy]:	Prepared by:
Architectural Plans – Appendix A				
Cover Sheet	DA-001	6	17/05/2024	Custance Associates Australia Pty Ltd
Site Analysis	DA-002	5	18/01/2024	Custance Associates Australia Pty Ltd
Development Data	DA-004	5	18/01/2024	Custance Associates Australia Pty Ltd
Site Plan	DA-005	6	17/05/2024	Custance Associates Australia Pty Ltd
General Arrangement Plan - Ground Level - Part 2	DA-006.A	4	17/05/2024	Custance Associates Australia Pty Ltd
General Arrangement Plan - Ground Level - Part 1	DA-006	8	17/05/2024	Custance Associates Australia Pty Ltd
General Arrangement Plan - Level 1	DA-007	8	17/05/2024	Custance Associates Australia Pty Ltd
Roof Plan	DA-008	5	18/01/2024	Custance Associates Australia Pty Ltd

Title / Name:	Drawing No. / Document Ref	Revision /	Date [dd/mm/yyyy]:	Prepared by:
External Elevations	DA-009	6	18/01/2024	Custance Associates Australia Pty Ltd
External Elevations	DA-010	6	18/01/2024	Custance Associates Australia Pty Ltd
External Elevations	DA-011	7	17/05/2024	Custance Associates Australia Pty Ltd
External Finishes	DA-012	5	18/01/2024	Custance Associates Australia Pty Ltd
Building Sections	DA-013	5	18/01/2024	Custance Associates Australia Pty Ltd
Shadow Diagrams	DA-014	5	18/01/2024	Custance Associates Australia Pty Ltd
Solar Access Studies - Bernadotte St	DA-015	5	18/01/2024	Custance Associates Australia Pty Ltd
Solar Access Studies - Internal Carpark	DA-016	6	17/05/2024	Custance Associates Australia Pty Ltd
Cut and Fill Diagrams	DA-017	3	18/01/2024	Custance Associates Australia Pty Ltd
Views from the Sun - Sheet 1	DA-018	4	17/05/2024	Custance Associates Australia Pty Ltd
Views from the Sun – Sheet 2	DA-019	4	17/05/2024	Custance Associates Australia Pty Ltd
Views from the Sun – Sheet 3	DA-020	4	17/05/2024	Custance Associates Australia Pty Ltd
Views from the Sun – Sheet 4	DA-021	4	17/05/2024	Custance Associates Australia Pty Ltd
Landscape Plans – Appendix B				
Landscape Coversheet	000	G	11/06/2024	Site Image
Existing Tree Master Plan	001	E	11/06/2024	Site Image
Landscape Masterplan (Colour)	C100	G	11/06/2024	Site Image
General Arrangement Plan 1	101	D	25/01/2024	Site Image
General Arrangement Plan 2	102	G	11/06/2024	Site Image
Planting Plan 1	201	E	25/01/2024	Site Image
Planting Plan 2	202	Н	11/06/2024	Site Image
Landscape Specification Notes & Planting Schedule	500	G	21/05/2024	Site Image
Landscape Details	501	В	03/11/2023	Site Image
Civil Plans - Appendix C	·	<u> </u>	·	·
Site Stormwater Plan	CSK01	G	13/06/2024	JN
Level 1 Stormwater Plan	CSK02	G	13/06/2024	JN
Roof Stormwater Plan	CSK03	G	13/06/2024	JN
WSUD Plan	CSK04	G	13/06/2024	JN
ESM Site Plan	ESM1	В	13/06/2024	JN
ESM Site Plan	ESM2	В	13/06/2024	JN
Survey Plans - Appendix D	<u> </u>		<u> </u>	

Title / Name:	Drawing No. /	Revision /	Date	Prepared by:	
	Document Ref	Issue:	[dd/mm/yyyy]:		
Detail and Level Survey	1 of 10	С	5/12/2023	Norton Survey Partners	
Detail and Level Survey	2 of 10	С	5/12/2023	Norton Survey Partners	
Detail and Level Survey	3 of 10	С	5/12/2023	Norton Survey Partners	
Detail and Level Survey	4 of 10	С	5/12/2023	Norton Survey Partners	
Detail and Level Survey	5 of 10	С	5/12/2023	Norton Survey Partners	
Detail and Level Survey	6 of 10	С	5/12/2023	Norton Survey Partners	
Detail and Level Survey	7 of 10	С	5/12/2023	Norton Survey Partners	
Detail and Level Survey	8 of 10	С	5/12/2023	Norton Survey Partners	
Detail and Level Survey	9 of 10	С	5/12/2023	Norton Survey Partners	
Detail and Level Survey	10 of 10	С	5/12/2023	Norton Survey Partners	
Survey Plan Showing Details and Levels	1 Of 1	A	19/12/2022	Mepstead and Associates	
Notification Plans – Appendix E					
Cover Sheet	N-01	2	21/12/2023	Custance Associates Australia Pty Ltd	
Site/Landscape Plan	N-02	А	14/02/2024	Custance Associates Australia Pty Ltd	
External Elevations	N-03	2	21/12/2023	Custance Associates Australia Pty Ltd	
External Elevations	N-04	2	21/12/2023	Custance Associates Australia Pty Ltd	
External Finishes	N-05	2	21/12/2023	Custance Associates Australia Pty Ltd	
Shadow Diagrams	N-06	2	21/12/2023	Custance Associates Australia Pty Ltd	
Access Report - Appendix H			'		
Access Report	23008-DA	R1.3	8/03/2024	Ai Consultancy	
AHIMS - Appendix I					
AHIMS search	-	-	16/04/2024	NSW Government	
Arborist's Report - Appendix J					
Arboricultural Impact Assessment	D4910	-	June 2024	Allied Tree Consultancy	
BASIX Certificate - Appendix K	'		'	'	
BASIX Certificate	1740102M	-	16/03/2024	Eco Engineering Group Pty Ltd	
BCA Report - Appendix L		, 	!	·	
BCA Compliance Assessment	P220164	2	6/12/2023	BCA Vision	
NatHERS Certificate - Appendix N	·		·		
Nationwide house energy rating scheme – class 2 summary	0009311090	-	18/03/2024	House Energy Certified	
Geotechnical Investigation Assessment - Appendix P					
Geotechnical Investigation Assessment	22/3102	-	September 2022	STS Geotechnic Pty Ltd	
Waste Management Plan - Appendix	· R		<u> </u>		

Title / Name:	Drawing No. / Document Ref	Revision / Issue:	Date [dd/mm/yyyy]:	Prepared by:
Waste Management Plan	-	-	-	Custance Associates Australia Pty Ltd
Traffic Report - Appendix S				
Traffic Impact and Parking Assessment	N0221293	В	22/11/2023	Jones Nicholson Pty Ltd

- 2. All building work is to be undertaken in accordance with the National Construction Code and referenced Australian Standards.
- **3.** All commitments listed in the BASIX certificate and stamped plans as required by identified requirement No. 64 shall be implemented.
- **4.** All construction documentation and building work is to be certified in accordance with Section 6.28 of the *Environmental Planning and Assessment Act 1979*.
- 5. The land the subject of this determination shall be consolidated into a single lot. The plan of consolidation shall be lodged at the NSW Land Registry Services and shall be registered prior to the occupation of the development. A copy of the registered plan shall be provided to the Land and Housing Corporation.

#### **OPERATIONAL MATTERS**

The following Identified Requirements relate to the use of the site and are to ensure that the activity and its operation do not interfere with the amenity of the surrounding area.

#### Stormwater Run-off

- 6. Stormwater shall be collected within the site and conveyed in a pipeline to the appropriate gutter or drain under the control of Georges River Council substantially in accordance with the approved concept stormwater drainage plans.
- 7. Alterations to the natural surface contours or surface absorption characteristics of the site shall not impede, increase or divert natural surface water runoff so as to cause a nuisance to adjoining property owners.
- **8.** All driveways shall be graded in such a manner as to provide continuous surface drainage flow paths to the appropriate points of discharge.
- **9.** To prevent water from entering buildings, surface waters shall be collected and diverted clear of the buildings by a sub-surface / surface drainage system.

#### Vehicular Access & Parking

- 10. Concrete vehicular crossings and laybacks shall be provided at the entrances / exits to the property. The crossings and laybacks shall be constructed in accordance with Georges River Council's standard requirements for residential crossings. Council shall be provided with plans for the crossings and laybacks together with the payment of any council inspection fees.
- 11. Particular care shall be taken in the location of vehicular crossings and/or laybacks to avoid poles, pits etc. The cost of any necessary adjustments to utility mains and services associated with the construction of the laybacks / driveways shall be borne by the Land

and Housing Corporation. Obsolete gutter layback(s) shall be constructed as kerb in accordance with Georges River Council's standards.

#### Note:

It is recommended that discussion be held with the relevant authorities before construction works commence.

12. Car parking spaces and driveways shall be constructed of concrete or other approved hard surfaced materials. The spaces must be clear of obstructions and columns, permanently line marked and provided with adequate manoeuvring facilities. The design of these spaces must comply with AS 2890.1.

#### Site Works

- 13. All soil erosion and sediment control measures required to be put in place prior to the commencement of construction works shall be maintained during the entire period of the works until all the disturbed areas are restored by turfing, paving or revegetation. Soil erosion and sediment control measures shall be designed in accordance with the guidelines set out in the Blue Book *Managing Urban Stormwater: Soils and Construction* (4th edition, Landcom, 2004).
- 14. An appropriately qualified person shall design retaining walls or other methods necessary to prevent the movement of excavated or filled ground, including associated stormwater drainage measures.

### **Building Siting**

15. All buildings shall be sited well clear of any easements affecting the site. The builder shall ascertain if any easements do exist and, if they do, obtain full details of such prior to construction commencing.

### Smoke Detection System(s)

- 16. Smoke detection systems shall be installed throughout the building(s) in accordance with requirements of Clause E2.2a of the Building Code of Australia. Detectors and alarms shall comply with AS 3786 and AS 1670 and must:
  - i. be connected to a permanent 240V power supply; and
  - ii. be provided with a battery backup to activate the alarm unit in the event of failure of the permanent power supply.

#### Site Soil Contamination

17. If the site is identified as being potentially affected by soil contamination, it shall be inspected by a suitably qualified person to identify any contaminated or hazardous material present. A proposal for remediation shall be prepared, which may include preparation of a Remedial Action Plan, and remediation shall be carried out in accordance with the proposal. A Validation Report, prepared in accordance with Environment Protection Authority requirements, shall be obtained from a qualified expert on completion of the remediation work to verify that the site is suitable for the intended residential use. A copy of the Validation Report shall be provided to the Land and Housing Corporation on completion of the remediation works.

#### Landscaping

- 18. Landscaping shall be carried out substantially in accordance with the approved landscape plans and maintained for a period of 12 months by the building contractor. Georges River Council shall be consulted in relation to the planting of any street trees.
- 19. All scheduled plant stock shall be pre-ordered, prior to commencement of construction or 3 months prior to the commencement of landscape construction works, whichever occurs sooner, for the supply to the site on time for installation. The builder shall provide written confirmation of the order to the Land and Housing Corporation.

#### Tree Removal

20. Removal of trees within the boundaries of the site is to be carried out in accordance with the trees shown for removal on the approved landscape plan and Arboricultural Impact Assessment report and no other trees shall be removed without further approval(s).

### **Fencing**

21. All front fencing and gates shall be constructed wholly within the boundaries of the site. Any gates associated with the fencing shall swing inwards towards the site.

#### **Provision of Letterbox Facilities**

**22.** Suitable letterbox facilities are to be provided in accordance with Australia Post specifications.

#### **Public Liability Insurance**

**23.** A valid public liability insurance policy of at least \$10M shall be maintained throughout the construction works by the contractor.

#### PRIOR TO ANY WORK COMMENCING ON THE SITE

The following Identified Requirements are to be complied with prior to any work commencing on the site.

#### Disconnection of Services

- 24. All services that are required to be disconnected shall be appropriately disconnected and made safe prior to commencement of the construction works. The various service authorities shall be consulted regarding their requirements for the disconnection of services.
- **25.** All existing services within the boundary to remain live shall be identified, pegged and made safe.

#### **Utilities Service Provider Notification**

26. The construction plans shall be submitted to the appropriate water utility's office (e.g. Sydney Water office) to determine whether or not the development will affect the utility's sewer and water mains, stormwater drains and any easements.

#### Note:

If the development complies with water utility's requirements, the plans will be stamped indicating that no further requirements are necessary.

#### **Council Notification**

**27.** Georges River Council shall be advised in writing, of the date it is intended to commence works. A minimum period of **five (5)** working days notification shall be given.

#### Neighbour notification

28. The builder shall notify the occupants of premises on either side, opposite and at the rear of the site a minimum of **five (5)** working days prior to commencement of construction. Such notification shall be clearly written on an A4 size paper giving the date construction will commence and be placed in the letterbox of every premise (including every unit in a multi-unit residential building or mixed use building). Construction shall not commence prior to the date that is stated in the notice letter.

#### Separate approval for demolition

29. Separate approval is to be obtained for the demolition of the existing dwellings and associated structures on the site. Demolition is to be completed prior to any construction work commencing on site.

#### Site Safety

- **30.** A sign shall be erected in a prominent position on any site on which building works or building work is being carried out:
  - (a) showing the name, address and telephone number of the responsible Land and Housing Corporation officer for the work, and
  - (b) showing the name of the principal contractor (if any) and a telephone number on which that person may be contacted outside working hours, and
  - (c) stating that unauthorised entry to the work site is prohibited.

The sign shall be maintained while the work is being carried out but shall be removed when the work has been completed.

#### Note:

This requirement does not apply in relation to building work that is carried out inside an existing building that does not affect the external walls of the building.

31. A minimum 1.8m high security fence or Class A / Class B (overhead) hoarding must be erected between the work site and any public place prior to construction. Access to the site shall be restricted to authorised persons only and the site shall be secured against unauthorised entry when construction work is not in progress or the site is otherwise unoccupied.

#### Note:

Approval from the relevant roads authority will be required under Section 138 of the Roads Act 1993 where a Class A or B hoarding encroaches onto the footpath of / or a public thoroughfare within a classified road.

**32.** No building materials are to be stored on the footpath or roadway.

#### Site Facilities

- **33.** The following facilities shall be installed on the site:
  - (a) Toilet facilities shall be provided at the rate of 1 toilet for every 20 persons or part thereof employed at the site. Each toilet provided shall be a standard flushing toilet and shall be connected to a public sewer or if connection to a public sewer is not practicable, to an accredited sewerage management facility provided by Georges River Council or if this is not practicable to some other council approved management facility.
  - (b) Adequate refuse disposal methods and builders storage facilities. Builders' wastes, materials or sheds shall not to be placed on any property other than that which this approval relates to.
- **34.** Access to the site shall only be provided via an all-weather driveway on the property and is not to be provided from any other site.

#### **Protection of Trees**

**35.** Trees and other vegetation that are to be retained on site and within the adjoining road reserve shall be protected prior to the commencement of works and for the duration of the construction period in accordance with the details provided in the Arboricultural Impact Assessment report.

#### Waste Management

**36.** A final Waste Management Plan shall be prepared and submitted to the Land and Housing Corporation by the building contractor prior to the commencement of construction. The plan shall detail the amount of waste material and the destination of all materials, recyclable and non-recyclable.

#### PRIOR TO ANY CONSTRUCTION WORK COMMENCING ON SITE

The following Identified Requirements are to be complied with prior to any construction works occurring on the site.

#### Service Authority Clearances

**37.** A compliance certificate, or other evidence, shall be obtained from Sydney Water confirming service availability prior to work commencing.

#### Note

Payment of water and/or sewer service charges and/or a notice of requirements for works to be carried out during construction / prior to occupation may be applicable prior to issue of the compliance certificate.

- **38.** A written clearance from an electricity supply authority stating that electrical services are available to the site, or that arrangements have been entered into for the provision of services to the site, shall be obtained prior to work commencing.
- **39.** A certificate from an approved telecommunications carrier certifying that satisfactory arrangements have been made for the provision of underground telephone services, to the site and to each dwelling, shall be obtained prior to work commencing.

**40.** Where the site is to be connected to reticulated gas, a certificate from an approved gas carrier to certify that satisfactory arrangements have been made to ensure the provision of underground gas services to each dwelling in the development shall be obtained prior to work commencing.

#### Stormwater Disposal

41. A detailed stormwater drainage plan(s), substantially in accordance with the approved concept stormwater drainage plan(s), shall be prepared and submitted to the Land and Housing Corporation. Any on-site detention system shall be designed in accordance with the relevant catchment authority's requirements (e.g. the Upper Parramatta River Catchment Trust On-site Detention Handbook) and/ or Georges River Council's drainage code.

#### **DURING CONSTRUCTION WORKS**

The following Identified Requirements are to be complied with whilst construction works are occurring on the site.

#### Landfill

- **42.** Where site filling is necessary, a minimum of 95% standard compacting shall be achieved and certified by a NATA registered Soils Lab.
- **43.** Land fill materials must satisfy the following requirements:
  - i. be Virgin Excavated Natural Matter (VENM);
  - ii. be free of slag, hazardous, contaminated, putrescible, toxic or radio-active matter; and
  - iii. be free of industrial waste and building debris.

#### Heritage

- 44. Historic and indigenous archaeological sites and relics are protected under the *Heritage Act 1977* and *National Parks and Wildlife Act 1974*, respectively. Should any relics be uncovered during the course of the approved works, work must cease immediately in the affected area. Subsequently, in cases where historical or indigenous items have been uncovered, the Department of Climate Change, Energy the Environment and Water must be contacted.
- **45.** All workers / contractors on the site shall be informed of their obligations, under the Heritage Act and *National Parks and Wildlife Act 1974*, that it is illegal to disturb, damage or destroy a relic without the prior approval of the Department of Climate Change, Energy the Environment and Water.

### **Survey Reports**

46. Survey reports shall be submitted by the building contractor to the Land and Housing Corporation prior to the placement of the footings / slab and on completion of the dwellings to verify the correct position of the structures in relation to the allotment boundaries.

#### Hours of Construction / Civil Work

**47.** Construction / civil work shall only occur on the site between the hours of 7.00am to 5.00pm Monday to Saturday with no work permitted on Sundays or public holidays.

#### **Excavation & Backfilling**

**48.** All excavations and backfilling associated with the erection of building(s) shall be executed safely and in accordance with appropriate professional standards. All such work shall be guarded and protected to prevent it from being dangerous to life or property.

#### **Pollution Control**

- **49.** Any noise generated during the construction of the development shall not exceed the limits specified in the July 2009 Interim Construction Noise Guidelines, published by the former Department of Environment and Climate Change.
- **50.** No fires shall be lit or waste materials burnt on the site.
- 51. No washing of concrete forms or trucks shall occur on the site.
- **52.** Any contamination / spills on the site during construction works shall be actively managed and reported immediately to appropriate regulatory authorities to minimise any potential damage to the environment.
- **53.** Dust generation during construction shall be controlled using regular control measures such as on site watering or damp cloth fences.
- **54.** All vehicles transporting loose materials and travelling on public roads shall be secured (i.e. closed tail gate and covered) to minimise dust generation.
- 55. Non-recyclable waste and containers shall be regularly collected and disposed of at a licensed landfill or other disposal site in accordance with details set out in the final Waste Management Plan.

#### Impact of Construction Works

- **56.** NSW Land and Housing Corporation shall bear the cost of any necessary adjustments to utility mains and services.
- 57. Care shall be taken to prevent any damage to adjoining properties. The building contractor shall be liable to pay compensation to any adjoining owner if, due to construction works, damage is caused to such adjoining property.

#### **Termite Protection**

**58.** To protect buildings from subterranean termite, termite barriers installed in accordance with AS 3660.1, shall be placed on the underside and in penetrations of the concrete slab floor.

In addition, a durable notice must be permanently fixed inside the meter box indicating:

(a) the method of protection,

- (b) the date of installation of the system,
- (c) where a chemical barrier is used, its life expectancy as listed on the National Registration Authority label, and
- (d) the need to maintain and inspect the system on a regular basis.

#### PRIOR TO OCCUPATION OF THE DEVELOPMENT

The following Identified Requirements are to be complied with prior to the occupation of the development.

#### General

**59.** The use or occupation of the development shall not commence until all the identified requirements of this determination have been complied with.

#### Council Infrastructure Damage

**60.** The cost of repairing any damage caused to Georges River Council's assets in the vicinity of the site as a result of construction works shall be met in full by the building contractor.

### Stormwater Drainage

- 61. Prior to occupation, a Work As Executed Plan shall be prepared by the building contractor clearly showing all aspects of the constructed stormwater drainage system, including any on-site detention system. The plan shall demonstrate general compliance with the approved concept stormwater drainage plan(s) and shall include:
  - sufficient levels and dimensions to verify the constructed storage volumes; and
  - location and surface levels of all pits; and
  - the structural adequacy of the On-Site Detention system; and
  - detention storage volume and attenuation in accordance with the submitted calculations; and
  - invert levels of the internal drainage lines, orifice plates fitted and levels within the outlet control pits; and
  - finished floor levels of all structures; and
  - verification that any required trash screens have been installed; and
  - locations and levels of any overland flow paths; and
  - verification that any drainage lines are located wholly within easements, where applicable.

The Work-As-Executed Plan information shall be shown on the final civil works drawings.

A positive covenant and restriction-as-to-user shall be placed over the onsite detention system in accordance with Georges River Council's on-site detention policy to ensure that the system will be adequately maintained. The positive covenant and restriction-as-to-user shall be registered at NSW Land Registry Services prior to occupation. A copy of the registered restriction-as-to-user shall be provided to the Land and Housing Corporation and Georges River Council.

### PART B - Additional Identified Requirements

#### 62. Air Conditioning

### Design and Installation

Air conditioning units as illustrated on architectural plans must be designed, specified and installed to ensure that they comply with the requirements of the Protection of the Environment Operations (Noise Control) Regulations 2017 and must not emit a noise that exceeds 5dB(A) above the ambient background noise level measured at any property boundary. Acoustic treatment may be required to ensure this is achieved.

Certification, from an appropriately qualified acoustic consultant, shall be provided at construction documentation stage that the air conditioning units can comply with this requirement.

Further certification, from an appropriately qualified acoustic consultant, shall be provided prior to occupation that the installed air conditioning units comply with this requirement.

### On-Going

The use of any air-conditioning unit must comply with the requirements of the Protection of the Environment Operations (Noise Control) Regulations 2017 and must not:

- (a) emit a noise that is audible within a habitable room in any adjoining residence (regardless of whether any door or window to that room is open);
  - (i) before 8.00 am and after 10.00 pm on any Saturday, Sunday or Public Holiday; or
  - (ii) before 7.00 am or after 10.00 pm on any other day;
- (b) emit a noise that exceeds 5dB(A) above the ambient background noise level measured at any property boundary.

### 63. Solar (photovoltaic electricity generating) energy system

Where a solar energy system is proposed it must satisfy the following requirements:

- (a) the system is installed in accordance with the manufacturer's specifications or by a person who is accredited by the Clean Energy Council for the installation of photovoltaic electricity generating systems, and
- (b) the solar energy system must not reduce the structural integrity of any building to which the system is attached, and
- (c) the system must not involve mirrors or lenses to reflect or concentrate sunlight, and
- (d) the system must not protrude more than 0.5m from the wall or roof (as measured from the point of attachment), and
- (e) the system is installed no less than 3m from any adjoining property boundary.

Certification from an appropriately person shall be provided at construction documentation stage that the solar energy system/s are capable of complying with this requirement.

#### 64. NatHERS & BASIX Certificates/ stamped plans

Updated BASIX and NatHERS Certificates and stamped plans prepared by an appropriately qualified person are to be provided at construction documentation stage detailing the inclusion of air conditioning and solar (photovoltaic electricity generating) energy system.

#### Specific Requirements for Seniors Housing

65. The independent living units shall comply with the accessibility and useability standards referenced in section 85 and set out in Schedule 4 of State Environmental Planning Policy (Housing) 2021.

#### Note:

This requirement does not apply to the provisions set out under sections 2, 7-13 and 15-20 of Schedule 4 for an independent living unit, or part of such a unit, that is located above the ground floor

- **66.** Only the following kinds of people shall be accommodated in the approved development:
  - (a) seniors or people who have a disability; or
  - (b) people who live in the same household with seniors or people who have a disability; or
  - (c) staff employed to assist in the administration and provision of services to the seniors housing development.

#### Note:

It should be noted that 'seniors', as defined in the Housing SEPP, are any of the following:

- (a) people aged 60 or more years,
- (b) people who are resident at a facility at which residential care (within the meaning of the Aged Care Act 1997 of the Commonwealth) is provided, and
- (c) people who have been assessed as being eligible to occupy housing for aged persons provided by a social housing provider.

A restriction as to user shall be registered against the title of the property, prior to occupation, in accordance with Section 88E of the Conveyancing Act 1919 limiting the use of any accommodation to the kinds of people referred to above and that the dwellings cannot be subdivided.

- 67. Pathway lighting shall be designed to provide a minimum of 20 lux at ground level and be located to avoid glare for pedestrians and adjacent dwellings.
- **68.** Access to, and within, the site shall be provided in accordance with AS 1428.1 so that a person using a wheelchair can use common areas and common facilities associated with the activity.

#### 69. Continuous Accessible Path of Travel

- A 1.2m wide concrete footpath shall be constructed across the site frontages, east of the western entrance in Munmurra Road, and from the site to the existing concrete footpath on the southern side of Broadarrow Road in accordance with Georges River Council specifications.
- The existing concrete footpath within Broadarrow Road, from Bernadotte Street to the nearest bus stops, shall be upgraded where necessary in accordance with the recommendations contained in the Access Report and Georges River Council specifications to provide an accessible pathway to the bus stops.

#### Note:

The responsible officer at Georges River Council shall be contacted regarding Council's specifications and any necessary approvals.

**70.** Entry doors to units shall be provided with door viewers to enable residents to view approaches to their units without the need to open the door.

#### Site Specific Requirements

#### 71. Boundary Fencing

To be metal panel (colour Monument or similar) a maximum 1.8m high behind the building line, tapering to 1.2m in height between the building line and front property boundary. Behind the building line to be a maximum 1.8m high.

- 72. Fencing along the front property boundaries to be a maximum 1.2m high.
- **73.** Fencing to the Private Open Space areas of Units 4, 5, 6, 7 and 8 to be maximum 1.5m high aluminium vertical slat with maximum 15mm gaps.

### Requirements Resulting from Council Comments

#### 74. Compliance with Flood Study

The development shall be designed to conform to the recommendations and conclusions of the submitted flood study prepared by JN responsive Engineering. This shall include, but not be limited to, any recommendations for the following:

- Minimum floor levels
- Fencing
- Site regrading
- Overland flow path construction.

Evidence from a professional engineer that specialises in hydraulic engineering shall be provided prior to occupation that this identified requirement has been adhered to.

### 75. Maintenance Schedule

Prior to occupation, a Maintenance Schedule for the proposed on-site stormwater management measures. The Maintenance Schedule shall outline the required maintenance works, how and when these will be done and who will be carrying out these maintenance works.

#### 76. Street Trees

An appropriate number of street trees are to be provided in suitable locations within Council's reserve at the site's frontages in consultation with Georges River Council staff.

#### 77. Pathway within the Road Reserve

- i. The construction documentation plans are to include updated finished levels to the footpath within the road reserve to match existing ground levels adjacent to trees 2, 3 and 4.
- ii. To be of flexible/ porous construction where required in the vicinity of Trees 2, 3 and 4 and in accordance with Georges River Council's specifications.
- iii. Access Report to be updated to provide an assessment of, and recommendations in relation to, the updated construction documentation plans.

### 78. Pruning Schedule

The project Arborist is to prepare a pruning schedule in accordance with AS4373—Pruning of amenity trees and provide a copy to Georges River Council.

### **ADVISORY NOTES**

- i. Approval of this development activity does not imply or infer compliance with Section 23 of the *Disability Discrimination Act 1992*. Refer to AS 1428.1 and the Building Code of Australia for detailed guidance.
- ii. Information regarding the location of underground services may be obtained from Dial Before You Dig at <a href="https://www.1100.com.au">www.1100.com.au</a> or by dialling 1100.



### **Decision Statement**

Project No. BGZEE

SITE IDENTIFICATION		
STREET ADDRESS		
Unit/Street No	Street or property name	
10-14	Munmurra Road	
5	Bernadotte Street	
Suburb, town or locality		Postcode
Riverwood		2210
Local Government Area(s)	Real property description (Lot and	DP)
Georges River	Lots 57, 58, 59 and 60 in Deposite	ed Plan 35818
ACTIVITY DESCRIPTION		
Provide a description of the activation	vity	
	uction of 16 seniors housing units comprised landscaping and fencing, surface parki	-

NSW Land & Housing Corporation (LAHC) has proposed the above activity under the provisions of *State Environmental Planning Policy (Housing)* 2021 (Housing SEPP) which requires determination under Part 5 of the *Environmental Planning* & *Assessment Act* 1979 (EP&A Act). This Decision Statement relates to the Review of Environmental Factors (REF) for the above activity prepared under Part 5 of the EP&A Act and the *Environmental Planning and Assessment Regulation* 2021.

Based on the REF document and supporting documentation, including advice from Georges River Council a decision to proceed with the proposed activity has been made. This decision included consideration of the following:

#### Significant Impact on the Environment

- The proposed activity is not likely to have a significant impact on the environment and therefore an EIS is not required.
- The proposed activity will not be carried out in a declared area of outstanding biodiversity value and is not likely to significantly affect threatened species, populations or ecological communities, or their habitats or impact biodiversity values, meaning a SIS and/or BDAR is not required.

#### Reasons for the Decision

 Following an assessment of the proposed activity and associated environmental impacts within the REF document it was decided that the proposed development will have economic and social benefits and any minor short-term impacts on the environment or surrounding properties can be appropriately mitigated.

#### Decision Statement: Seniors Housing Development at 10-14 Munmurra Road & 5 Bernadotte Street, Riverwood

 The proposed development will assist in the provision of much needed social and affordable housing and assist in addressing the existing and growing demand for housing in the Georges River local government area.

#### Mitigation Measures

 Mitigation measures are required to minimise or manage environmental impacts and are detailed throughout the REF and specifically within Section 8. All mitigation measures are detailed as Identified Requirements within the Activity Determination. Additional mitigation measures, detailed in the Activity Determination have been imposed to minimise the impact on the surrounding environment, ensure appropriate site safety and to ensure legislative compliance.

Yolanda Gil Acting Executive Director, Portfolio Strategy and Origination Housing Portfolio, Homes NSW

PART 5 ISSUE DA PART 5 ISSUE DA PART 5 REVISED FOLLOWING PLANNERS COMMENTS ON THE 09/01/24.

# 10-14 MUNMURRA ROAD & 5 BERNADOTTE ST, RIVERWOOD, NSW. NSW SENIOR'S HOUSING DEVELOPMENT



PROPOSED DEVELOPMENT SITE OWNED BY THE LAND AND HOUSING CORPORATION

DEVELOPMENT DATA TABLE

PROPOSED DEVELO	PMENT DATA - SEPP HO	USING 2021			
Site Area	2493 m²				
Number of dwellings	16 (8 x 1 Bed 8 x 2 Bed)				
	Control	Requirement	Proposed		
Front Setback	Georges River DCP	4.5m	6.3m / 6.4m		
Side Setback	Georges River DCP	4m	3.4m / 3m		
Rear Setback	Georges River DCP	6m	16.4m / 8.4m		
Height	SEPP Housing 2021	9.5m building height (top of ridge)	8.7m maximum		
Floor Space Ratio	SEPP Housing 2021	0.5 : 1	0.51 : 1		
	Georges River LEP	0.5 : 1	0.51 : 1		
Landscape	SEPP Housing 2021	35m2 per unit = 560m2.	971m2.		
Deep Soil Zone 15% of site with minimum dimensions of 3m	SEPP Housing 2021	15/100 x 2493 = 374m²	712m²		
65% of this at rear	SEPP Housing 2021	65/100 x 712 = 462m <sup>2</sup>	363m²		
70% of dwellings to have two hours sunlight to living areas and to associated private open space	SEPP Housing 2021	70/100 x 16 = 11.2 (12)	13/16 units - 81.2%		
Parking	SEPP Housing 2021	1 bed = 0.5 2 bed = 1 = 12	12		



BERNADOTTE STREET



## CORNER OF MUNMURRA & BERNADOTTE STREET

	DA DRAWING LIST	
SHEET NO	SHEET NAME	CURREN' REVISION
DA-001	COVER SHEET	6
DA-002	SITE ANALYSIS	5
DA-004	DEVELOPMENT DATA	5
DA-005	SITE PLAN	6
DA-006	GENERAL ARRANGEMENT PLAN - GROUND LEVEL - PART 1	8
DA-006.A	GENERAL ARRANGEMENT PLAN - GROUND LEVEL - PART 2	4
DA-007	GENERAL ARRANGEMENT PLAN - LEVEL 1	8
DA-008	ROOF PLAN	5
DA-009	EXTERNAL ELEVATIONS	6
DA-010	EXTERNAL ELEVATIONS	6
DA-011	EXTERNAL ELEVATIONS	7
DA-012	EXTERNAL FINISHES	5
DA-013	BUILDING SECTIONS	5
DA-014	SHADOW DIAGRAMS	5
DA-015	SOLAR ACCESS STUDIES - BERNADOTTE ST	5
DA-016	SOLAR ACCESS STUDIES - INTERNAL CARPARK	6
DA-017	CUT AND FILL DIAGRAMS	3
DA-018	VIEWS FROM THE SUN - SHEET 1	4
DA-019	VIEWS FROM THE SUN - SHEET 2	4
DA-020	VIEWS FROM THE SUN - SHEET 3	4
DA-021	VIEWS FROM THE SUN - SHEET 4	4

### Part 5 Submission

### **NOTES: DEVELOPMENT APPLICATION**

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### THIS DRAWING IS TO BE PRINTED IN COLOUR

Landscape Architect: Site Image Access Consultant: Ai Access Mechanical: Knox Structural: JN Civil / Stormwater: JN Hydraulic: JN Electrical: JN BASIX / Nathers Certification





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PH (02) 9051 0177

10-14 MUNMURRA RD. & 5 BERNADOTTE ST, RIVERWOOD, NSW 2210 LOTS 57,58,59 & 60 in SENIOR HOUSING DEVELOPMENT

**COVER SHEET** 

Р	RW	As indicated @ A1
rawn	Checked	Scale

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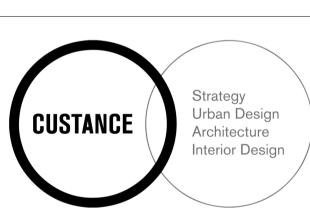
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Traffic Consultant:



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10-14 MUNMURRA RD. & 5 BERNADOTTE ST, RIVERWOOD, NSW 2210 LOTS 57,58,59 & 60 in SENIOR HOUSING DEVELOPMENT

### SITE ANALYSIS



As indicated @ A1

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18/09/2023 04/10/2023 17/11/2023 DA PART 5 ISSUE
DA PART 5 REVISED FOLLOWING PLANNERS
COMMENTS ON THE 09/01/24. 21/12/2023 18/01/2024



BLOCK PLAN - NEIGHBOURHOOD & SURROUNDING AREAS

1 EXISTING MULTI-UNIT DEVELOPMENT

2 EXISTING DUPLEX DEVELOPMENT

3 EXISTING MULTIPLEX DEVELOPMENT


















VIEW 6


WIND ROSE ANALYSIS

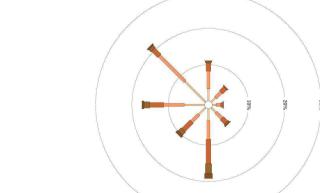

>= 0 and < 10

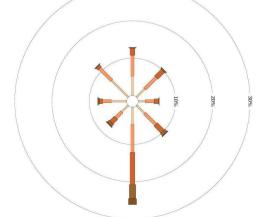

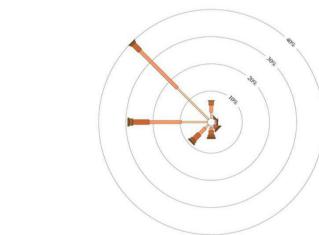

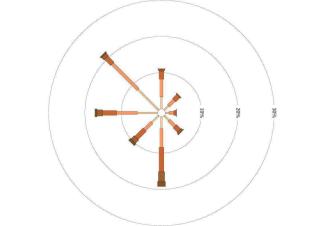


VIEW 2

VIEW 5

>= 10 and < 20

20 >= 30 and < 40 >= 20 and < 30

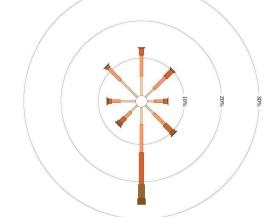



SUMMER

SITE ANALYSIS PLAN

NEIGHBOURING PROPERTY NEIGHBOURING PROPERTY NEIGHBOURING PROPERTY

NEIGHBOURING PRIVATE OPEN SPACE (P.O.S)

**MORNING** NEIGHBOURING PROPERTY **EVENING** 

SITE

AUTUMN

VIEW 1

VIEW 4

WINTER

18/09/2023

04/10/2023

17/11/2023

21/12/2023

18/01/2024

LEGEND

Tree Number

Existing trees to be removed **Existing Buildings** 

to be removed SRZ

Proposed

Existing

Indicative Deep soil zone

RW = Proposed retaining wall / downturn Footpath / Ramps

3600x3300

FLOOR FINISHES NS-CT Non Slip Ceramic Tile Carpet KEY:

lines

LxW

FLOOR FINISH

TS vertical timber battern screen around clothes

ROOM NAME. eg. BEDROOM 2.

Trees to be retained

Revision Description

Part 5 Submission

NOTES: DEVELOPMENT APPLICATION

DRAFT PART 5 SUBMISSION

DA PART 5 ISSUE
DA PART 5 REVISED FOLLOWING PLANNERS
COMMENTS ON THE 09/01/24.

PART 5 SUBMISSION

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Structural: JN Civil / Stormwater: JN Hydraulic: JN Electrical: JN BASIX / Nathers Certification: Traffic Consultant:



SYDNEY


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10-14 MUNMURRA RD. & 5 BERNADOTTE ST, RIVERWOOD, NSW 2210 LOTS 57,58,59 & 60 in DP 35818 SENIOR HOUSING DEVELOPMENT

Sheet Title

### DEVELOPMENT DATA



Checked RW As indicated @ A1
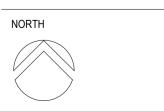
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Project No.







1 FSR - GROUND LEVEL 1 : 300

### DEVELOPMENT DATA


Totals

DEVELOPMENT DATA	ı		
	FSR	PrivateOpen Space	Total
UNIT 1 - 1 BED	58.58m2	15.04m2	73.62m2
UNIT 2 - 2 BED	73.57m2	15.62m2	89.19m2
UNIT 3 - 2 BED	80.50m2	15.36m2	95.86m2
UNIT 4 - 2 BED	74.51m2	15.26m2	89.77m2
UNIT 5 - 1 BED	60.98m2	17.07m2	78.05m2
UNIT 6 - 1 BED	59.92m2	15.00m2	74.92m2
UNIT 7 - 1 BED	59.87m2	15.00m2	74.87m2
UNIT 8 - 2 BED	76.17m2	15.00m2	91.17m2
UNIT 9 - 1 BED	58.58m2	11.08m2	69.66m2
UNIT 10 - 2 BED	73.57m2	11.63m2	85.20m2
UNIT 11 - 2 BED	80.50m2	12.32m2	92.82m2
UNIT 12 - 2 BED	74.51m2	15.38m2	89.89m2
UNIT 13 - 1 BED	61.42m2	10.76m2	72.18m2
UNIT 14 - 1 BED	59.92m2	10.34m2	70.26m2
UNIT 15 - 1 BED	59.87m2	10.12m2	69.99m2
UNIT 16 - 2 BED	76.17m2	10.02m2	86.19m2
LOBBY 1.	23.61m2		
LOBBY 2.	30.05m2		
LOBBY 3.	24.92m2		
LOBBY 4.	16.24m2		
LOBBY 5.	30.85m2		
LOBBY 6.	25.19m2		

1239.50m2

215.00m2

1454.5m2

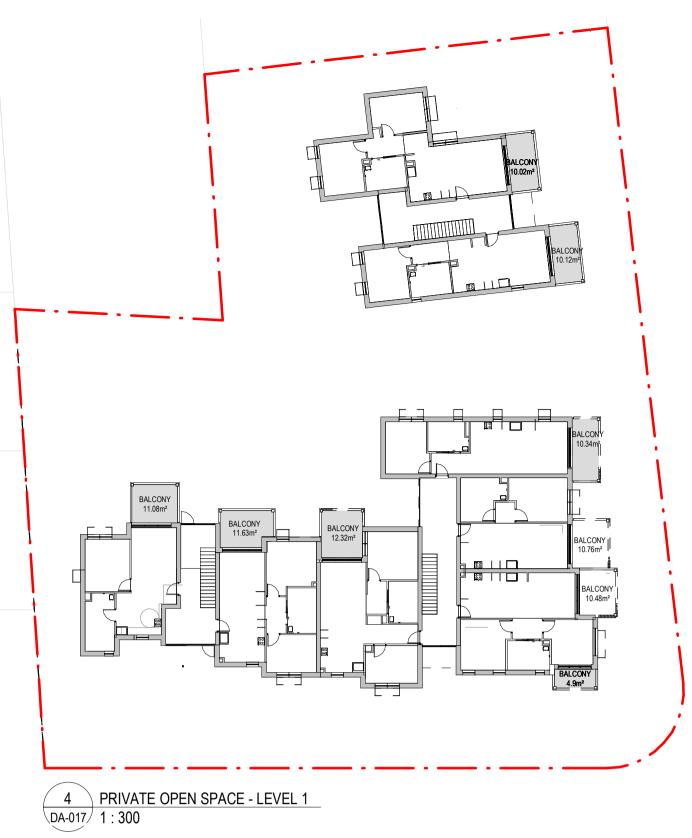











LEGEND

P.O.S (Min 3x3)

Landscaping

DRAFT PART 5 SUBMISSION 18/09/2023 PART 5 SUBMISSION 04/10/2023 PART 5 ISSUE 17/11/2023 DA PART 5 ISSUE 21/12/2023 DA PART 5 REVISED FOLLOWING PLANNERS 18/01/2024 COMMENTS ON THE 09/01/24.

DA PART 5 REVISED FOLLOWING CLIENTS EMAIL ON 17/05/2024

Part 5 Submission

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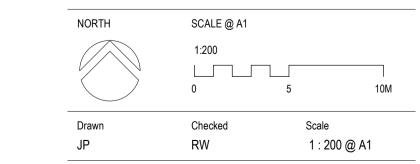
SYDNEY

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### SITE PLAN




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1 SITE PLAN





1 GROUND FLOOR PLAN - PART 2

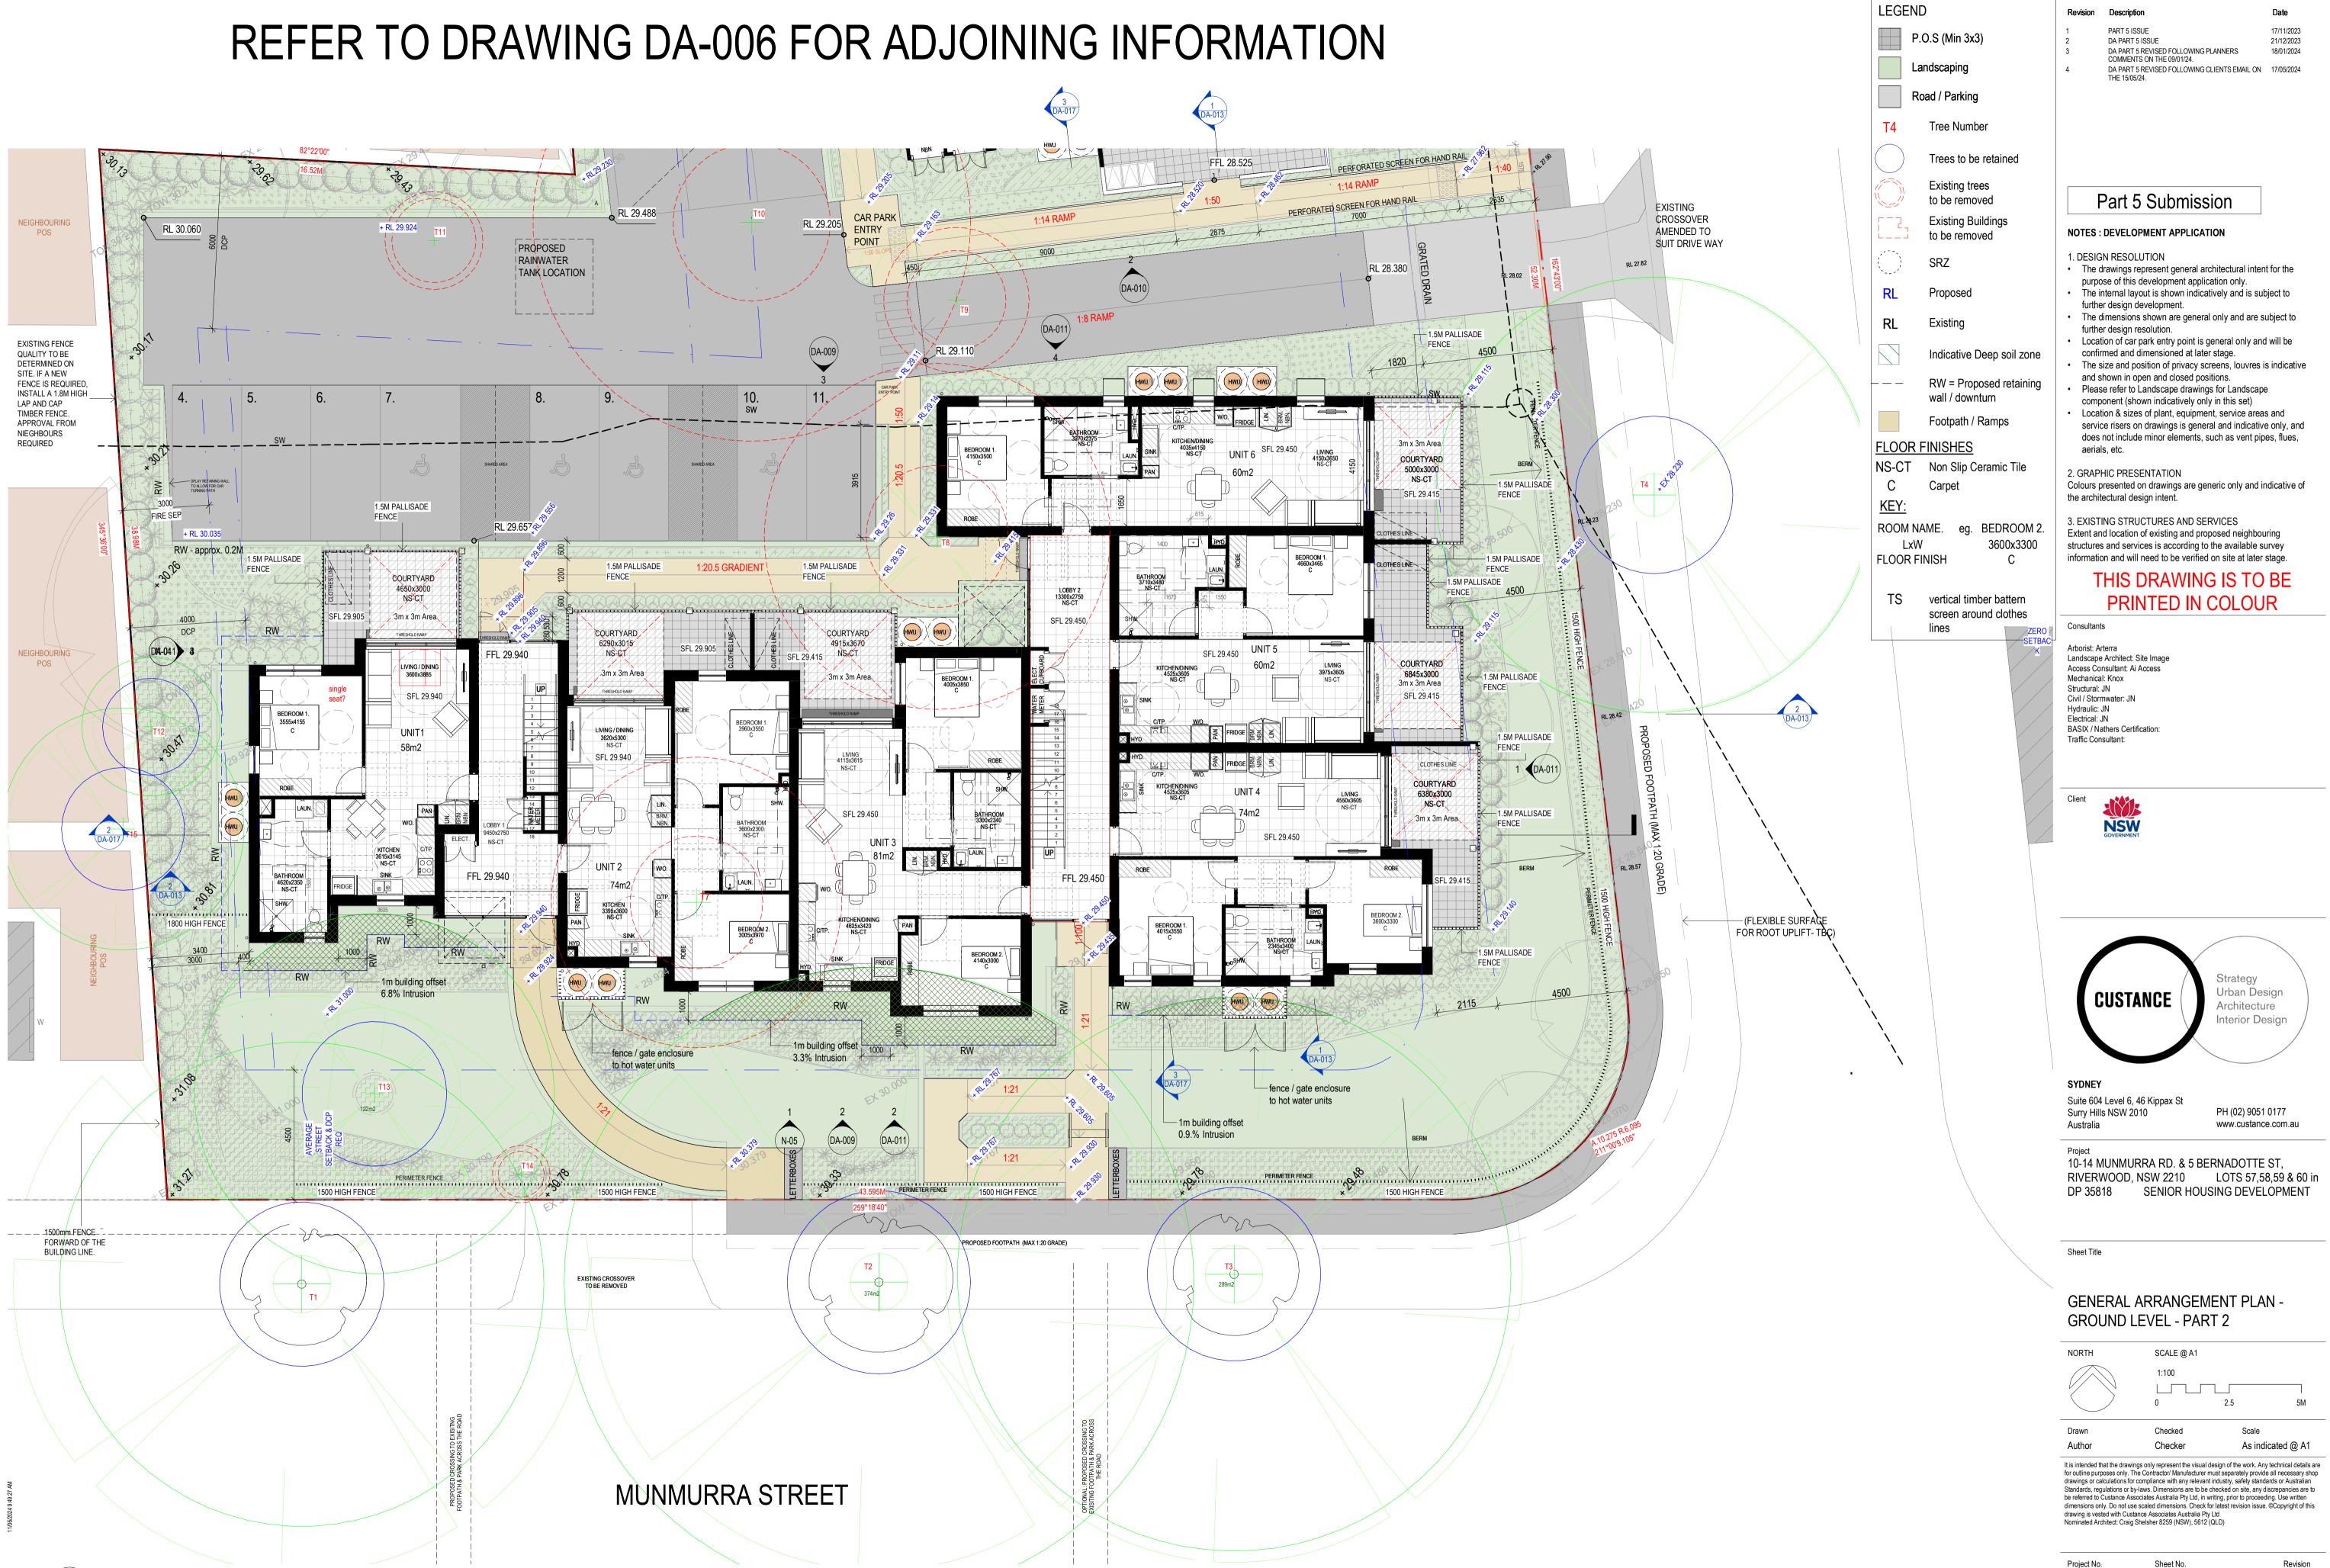DA-006.A 4

10/05/23

02/08/2023

18/09/2023

04/10/2023

17/11/2023

21/12/2023

18/01/2024



LEGEND P.O.S (Min 3x3)

Road / Parking

Trees to be retained Existing trees

**Existing Buildings** to be removed

Proposed

SPLAY FENCING

TO ALIGN WITH

FENCE HEIGHT

FORWARD OF THE

BUILDING LINE.

PROPOSED OSD

5000x3000 NS-CT

SFL 28.950

LOCATION

UNDER CARSPACE

SFL 28.985

LOBBY 2 13300x2750 NS-CT

SFL 29.450/

UNIT 8

ALONG BOUNDARY

FRONT BOUNDARY

1.5M PALLISADE

1.5M PALLISADE

1.5M PALLISADE

1.5M PALLISADE FENCE

1.5M PALLISADE

-1.5M PALLISADE FENCE

1.5M PALLISADE

1.5M PALLISADE

FENCE

FENCE

COURTYARD 5000x3000 NS-CT

FENCE

FENCE +

SFL 28.950 📝

COURTYARD 5000x3000

FENCE

RL 27.38

-EXISTING HEDGE TO

TREE DEEMED DEAD

 $\Box$ 

Ш

RNAD

吊

STREE

EXISTING

CROSSOVER

AMENDED TO

SUIT DRIVE WAY

DA-010

4 (N-03)

DA-009

1 GROUND FLOOR PLAN - PART 1

BY ARBORIST;

REMOVE

TRIM HEDGE TO

ALLOW FOR

ENTRY PATH

-EXISTING HEDGE TO

REMAIN

SUGGESTED TO

Existing

RW = Proposed retaining

NS-CT Non Slip Ceramic Tile Carpet KEY:

ROOM NAME. eg. BEDROOM 2. LxW FLOOR FINISH

Landscaping

Tree Number

to be removed

Indicative Deep soil zone

wall / downturn

Footpath / Ramps

FLOOR FINISHES

vertical timber battern screen around clothes

PART 5 SUBMISSION PART 5 ISSUE DA PART 5 ISSUE DA PART 5 REVISED FOLLOWING PLANNERS COMMENTS ON THE 09/01/24. DA PART 5 REVISED FOLLOWING CLIENTS EMAIL ON 17/05/2024

Revision Description

ISSUE FOR REVIEW

ISSUE TO LANDSCAPE ARCHITECT

DRAFT PART 5 SUBMISSION

Part 5 Submission

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10-14 MUNMURRA RD. & 5 BERNADOTTE ST RIVERWOOD, NSW 2210 LOTS 57,58,59 & 60 in SENIOR HOUSING DEVELOPMENT

GENERAL ARRANGEMENT PLAN -**GROUND LEVEL - PART 1** 

SCALE @ A1

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1.5M PALLISADE FENCE

> COURTYARD 4915x3670 NS-CT

RL 29.205

ENTRY

POINT

EXISTING FENCE QUALITY TO BE

DETERMINED ON

SITE. IF A NEW

LAP AND CAP

TIMBER FENCE.

NIEGHBOURS =

REQUIRED

RL 29.488

1.5M PALLISADE

6290x3015 NS-CT

PROPOSED

RAINWATER TANK LOCATION

RL 29.657

1.5M PALLISADE

COURTYARD

4650x3000

FENCE

1.5M PALLISADE

PROPOSED OSD

LOCATION UNDER

CARSPACES

DETERMINED ON

SITE. IF A NEW FENCE IS REQUIRED,

INSTALL A 1.8M HIGH

LAP AND CAP TIMBER FENCE. APPROVAL FROM NIEGHBOURS 🖾

REQUIRED

RL 30.060

**EXISTING FENCE** 

QUALITY TO BE

DETERMINED ON SITE. IF A NEW

FENCE IS REQUIRED,

INSTALL A 1.8M HIGH LAP AND CAP TIMBER FENCE. APPROVAL FROM **NIEGHBOURS** REQUIRED

APPROVAL FROM

FENCE IS REQUIRED.

INSTALL A 1.8M HIGH

10/05/23

18/09/2023


04/10/2023

06/10/2023

17/11/2023

21/12/2023

18/01/2024

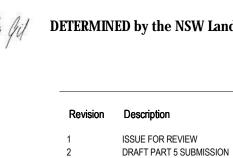

Part 5 Submission

DA PART 5 REVISED FOLLOWING PLANNERS COMMENTS ON THE 09/01/24.

DA PART 5 REVISED FOLLOWING CLIENTS EMAIL ON 17/05/2024 THE 15/05/24.

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PART 5 SUBMISSION

PART 5 SUBMISSION

PART 5 ISSUE

DA PART 5 ISSUE

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3. EXISTING STRUCTURES AND SERVICES
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# THIS DRAWING IS TO BE PRINTED IN COLOUR

### Consultants

Arbonst: Arterra
Landscape Architect: Site Image
Access Consultant: Ai Access
Mechanical: Knox
Structural: JN
Civil / Stormwater: JN
Hydraulic: JN
Electrical: JN
BASIX / Nathers Certification:

Client

Traffic Consultant:

CUSTANCE

Strategy
Urban Design
Architecture
Interior Design

SYDNEY


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10-14 MUNMURRA RD. & 5 BERNADOTTE ST, RIVERWOOD, NSW 2210 LOTS 57,58,59 & 60 in DP 35818 SENIOR HOUSING DEVELOPMENT

Sheet Title

### GENERAL ARRANGEMENT PLAN -LEVEL 1




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Project No. Sheet No. 3418

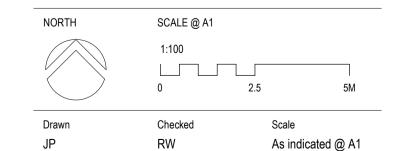2 LEVEL 1 FLOOR PLAN 1:100

DA-007

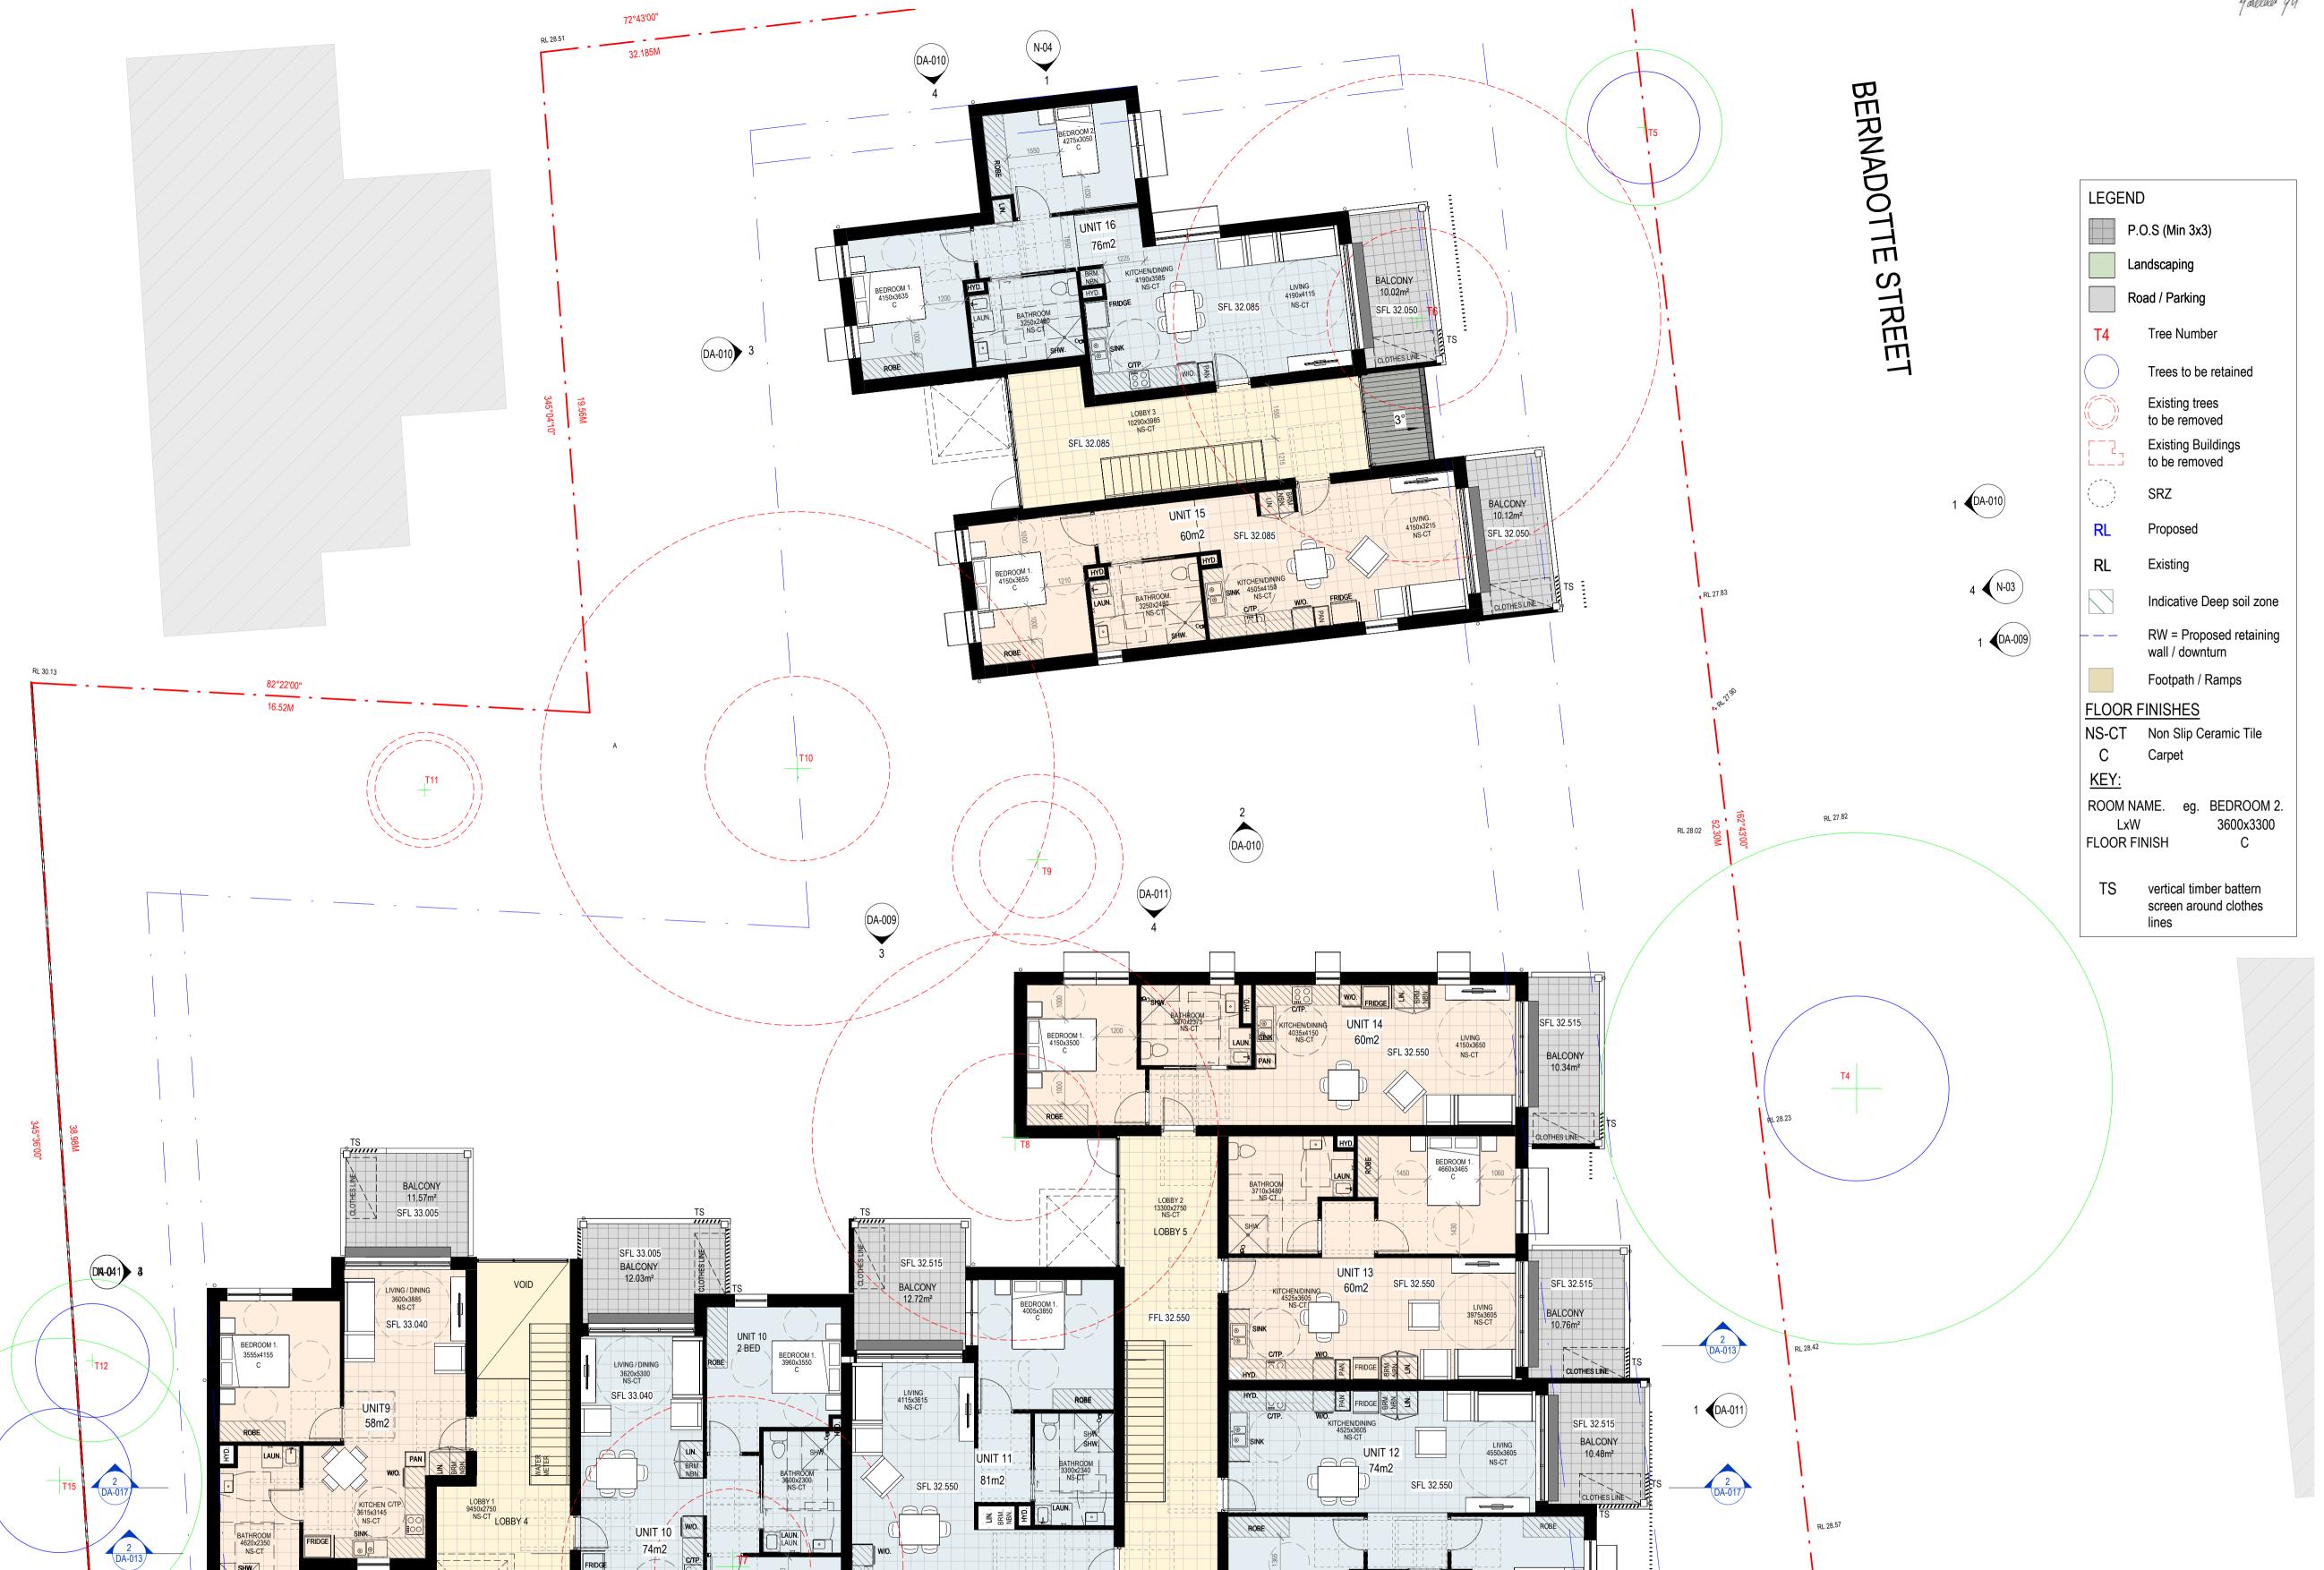

BEDROOM 1. 4015x3550

DA-009

259°18'40"

DA-011

BALCONY 4.9m² SFL 32.515

PERIMETER FENCE



**KEY** GU = GUTTER MC = METAL CLADDING (ROOF) REFER ALSO TO THE EXTERNAL FINISHES SCHEDULE

BERNADOTTE

STREET

1 (DA-010)

1 (DA-009)

SOLAR PANEL SYSTEM TO BE

- ABLE TO PROVIDE TO COMMON

LOBBY SPACES AND HW UNITS.

36.518

GU

5° FALL

MC

36.518

GU

METAL GUTTERS

REFER SCHEDULES

METAL ROOFING 36.254 REFER SCHEDULES

35.375

(DA-009)

SOLAR PANEL SYSTEM TO BE ABLE TO PROVIDE TO COMMON LOBBY SPACES AND HW UNITS.

38.122

GU

(DA-009)

MC

(DM-041)

36.198

MC

36.719

36.719

SOLAR PANELS

GU

37.457

36.657

35.555

**AWNING** 

5° FALL

- MC

GU

AWNING

ROOF

DM-030 3

GU MC

10° FALL

MC

METAL ROOFING

REFER SCHEDULES

MC GU

GU

36.645

MC

32.910

**AWNING** 

ROOF-

35.055

35.055

AWNING

3° FALL

GU

35.570

3° FALL

3° FALL

3° FALL

35.555

INDICATIVE -SOLAR PANEL LOCATION

35.570

35.570

GU

METAL GUTTERS

REFER SCHEDULES

3 (DM-041)

- MC

35.539

ROOF

3° FALL

35.949

DRAFT PART 5 SUBMISSION 18/09/2023 PART 5 SUBMISSION 04/10/2023 PART 5 ISSUE 17/11/2023 DA PART 5 ISSUE 21/12/2023 DA PART 5 REVISED FOLLOWING PLANNERS COMMENTS ON THE 09/01/24. 18/01/2024

### Part 5 Submission

### **NOTES: DEVELOPMENT APPLICATION**

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### 2. GRAPHIC PRESENTATION

aerials, etc.

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### Consultants

Arborist: Arterra Landscape Architect: Site Image Access Consultant: Ai Access Mechanical: Knox Structural: JN Civil / Stormwater: JN Hydraulic: JN Electrical: JN BASIX / Nathers Certification: Traffic Consultant:





### SYDNEY


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Sheet Title

# **ROOF PLAN**



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DA-008

FIRE SEP

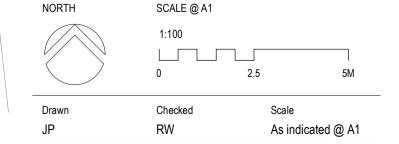DM-041 3

DCP

36.045

36.045

MC GU

10° FALL

18/09/2023

04/10/2023

06/10/2023

17/11/2023

21/12/2023

18/01/2024



2 MUNMURRA STREET - SOUTH ELEVATION DA-006.A 1:100



Part 5 Submission

DA PART 5 REVISED FOLLOWING PLANNERS COMMENTS ON THE 09/01/24.

### **NOTES: DEVELOPMENT APPLICATION**

DRAFT PART 5 SUBMISSION

PART 5 SUBMISSION

PART 5 SUBMISSION

PART 5 ISSUE

DA PART 5 ISSUE

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Sheet Title

Project No.

### EXTERNAL ELEVATIONS

	1:100		
	0	2.5	5M
Drown	Checked	Scale	
Drawn	Checked	Scale	
JP	RW As indicated @ A1		

SCALE @ A1

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18/09/2023

04/10/2023

06/10/2023

17/11/2023

21/12/2023

18/01/2024



- 1. "Bluegum" Wall Cladding
- 2. "Basalt" Wall Cladding

FINISHES LEGEND

- 3. Medium Face brick 4. Dark Face brick
- 5. Concrete Balcony wall
- 6. "Monument" downpipes
- 7. "Southerly" roofing
- 8. Breeze block wall
- 9. Pallisade fencing
- 10. "Monument" guttering
- 11. Balustrade screen to
- ramped path. 12. Balcony screening (Timber)

## Part 5 Submission

DA PART 5 REVISED FOLLOWING PLANNERS

### **NOTES: DEVELOPMENT APPLICATION**

DRAFT PART 5 SUBMISSION

COMMENTS ON THE 09/01/24.

PART 5 SUBMISSION

PART 5 SUBMISSION

PART 5 ISSUE

DA PART 5 ISSUE

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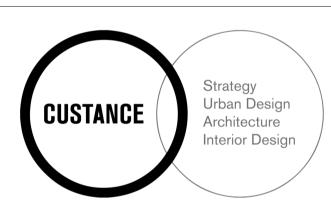
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Traffic Consultant:

Arborist: Arterra Landscape Architect: Site Image Access Consultant: Ai Access Mechanical: Knox Structural: JN Civil / Stormwater: JN Hydraulic: JN Electrical: JN BASIX / Nathers Certification:




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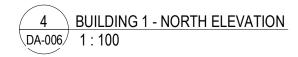
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Project No.





7 SOLAR PANELS 2 11 11 1 SOLAR PANELS (BEYOND) Roof - North
35085 Ground - North \_ 28985 HYDRANT BOOSTER ASSEMBLY WITH GATE / FENCE EXISTING HEDGE

1 BUILDING 1 - EAST ELEVATION \DA-006\/ 1:100

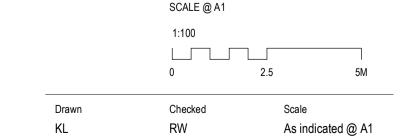
9.5m HEIGHT LINE (APPROX)



### 2 BUILDING 1 - SOUTH ELEVATION DA-006 1:100



BUILDING 1 - WEST ELEVATION
1: 100

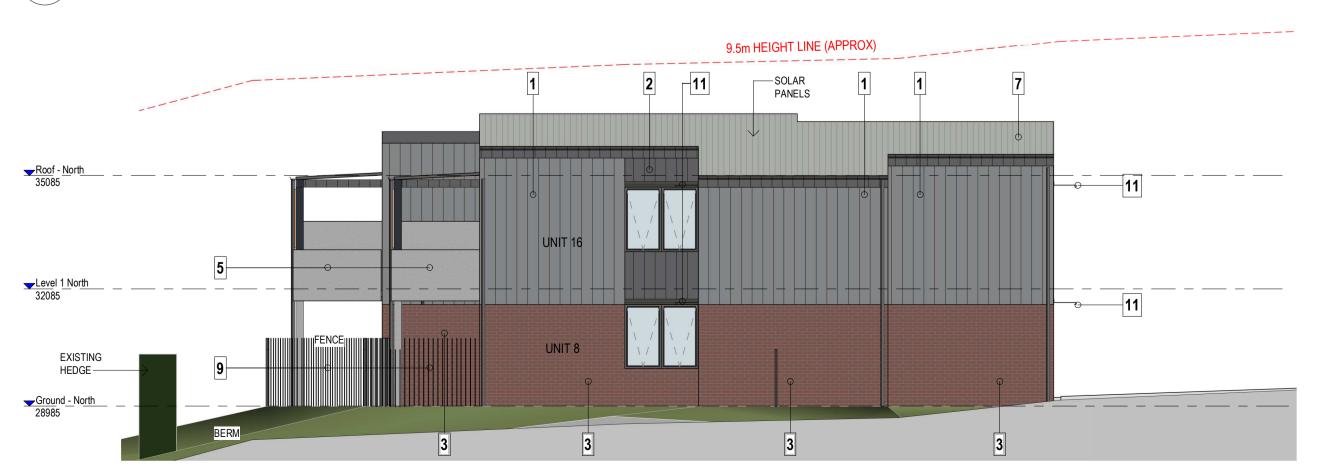



1. "Bluegum" Wall Claddir

FINISHES LEGEND

- 2. "Basalt" Wall Cladding 3. Medium Face brick
- 4. Dark Face brick
- 5. Concrete Balcony wall 6. "Monument" downpipes
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Revision	Description	Date
1	DRAFT PART 5 SUBMISSION	18/09/20
2	PART 5 SUBMISSION	04/10/20
3	PART 5 SUBMISSION	06/10/20
4	PART 5 ISSUE	17/11/20
5	DA PART 5 ISSUE	21/12/20
6	DA PART 5 REVISED FOLLOWING PLANNERS COMMENTS ON THE 09/01/24.	18/01/20
7	DA PART 5 REVISED FOLLOWING CLIENTS EMAIL ON THE 15/05/24.	17/05/20
	1 2 3 4 5	1 DRAFT PART 5 SUBMISSION 2 PART 5 SUBMISSION 3 PART 5 SUBMISSION 4 PART 5 ISSUE 5 DA PART 5 ISSUE 6 DA PART 5 REVISED FOLLOWING PLANNERS COMMENTS ON THE 09/01/24. 7 DA PART 5 REVISED FOLLOWING CLIENTS EMAIL ON

### Part 5 Submission

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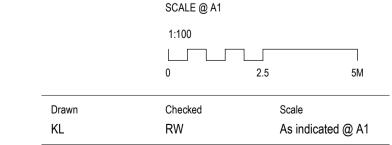
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# 2 BUILDING 2 - SOUTH ELEVATION



# 3 BUILDING 2 - WEST ELEVATION 1: 100




## **MATERIALS & COLOURS**




1. MEDIUM COLOURED WALL CLADDING



2. DARK COLOURED WALL CLADDING

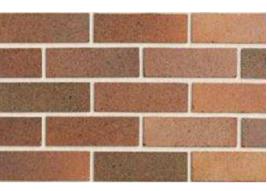

3. MEDIUM FACE BRICK

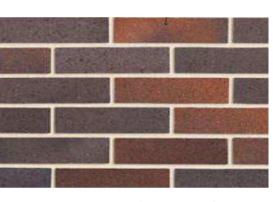

4. DARK FACE BRICK



5. CONCRETE BALCONY



6. DARK COLOURED DOWNPIPES, FACIAS, FLASHINGS, BALCONY POSTS & AWNINGS



7. LIGHT COLOUR ROOFING




8. BREEZE BLOCK



9. PALLISADE FENCE



10. DARK GUTTERS

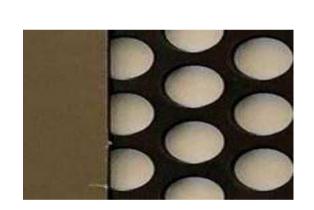

11. BALUSTRADE SCREEN TO RAMPED PATH.



12. LIGHT BALCONY SCREENING



### DETERMINED by the NSW Land and Housing Corporation on: 28.06.24

Revision Description DRAFT PART 5 SUBMISSION 18/09/2023 PART 5 SUBMISSION 04/10/2023 PART 5 ISSUE 17/11/2023 DA PART 5 ISSUE
DA PART 5 REVISED FOLLOWING PLANNERS
COMMENTS ON THE 09/01/24. 21/12/2023 18/01/2024

### Part 5 Submission

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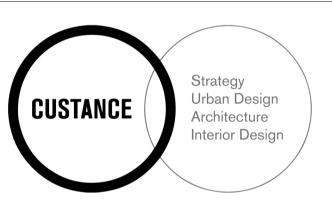
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# PRINTED IN COLOUR

Consultants Landscape Architect: Site Image Access Consultant: Ai Access Mechanical: Knox Structural: JN Civil / Stormwater: JN

Hydraulic: JN Electrical: JN BASIX / Nathers Certification: Traffic Consultant:





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Sheet Title

### EXTERNAL FINISHES

Drawn	Checked	Scale
JP	RW	As indicated @ A

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Project No.



PART 5 SUBMISSION

PART 5 ISSUE

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Sheet Title


### **BUILDING SECTIONS**

	SCALE @ A1		
	1:100		
	0	2.5	5M
Drawn	Checked	Scale	

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Project No.

As indicated @ A1

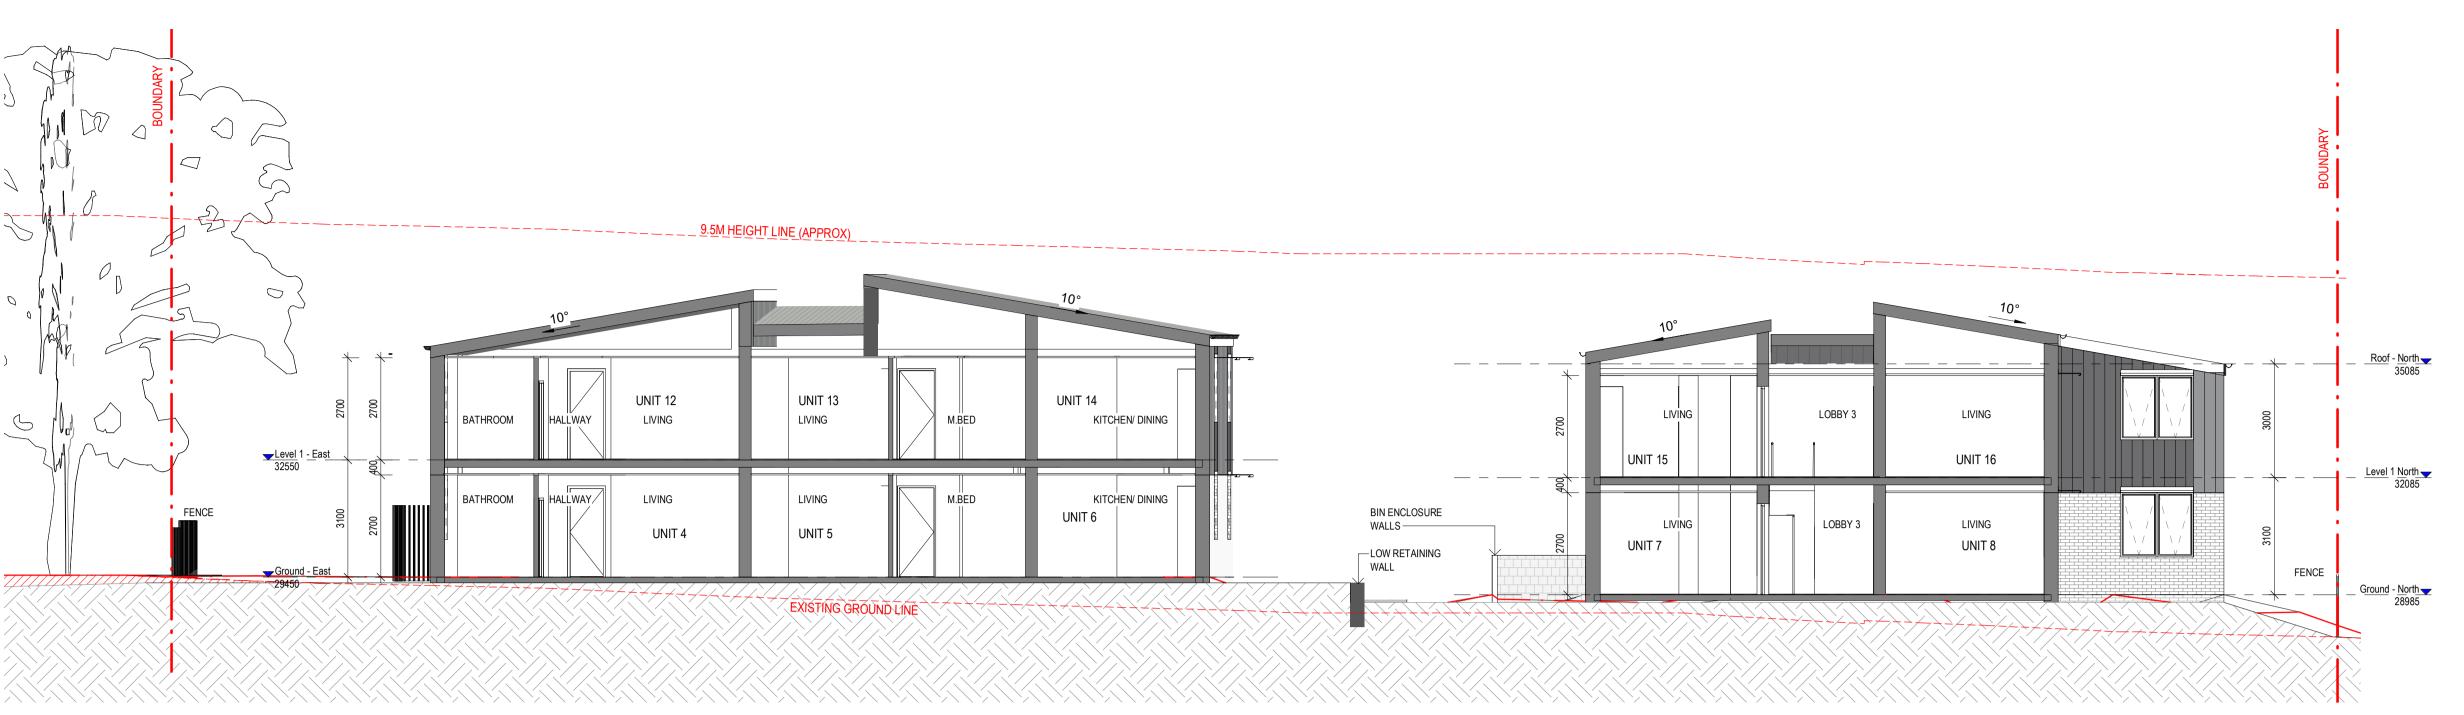

1 SECTION 1 - SECTION BERNADOTTE DA-006 1:100



2 SECTION 2 - SECTION MUNMURRA
DA-006.A 1:100

MUNMURRA STREET

MUNMURRA STREET

SHADOW DIAGRAM - 2pm. 21st June

SHADOW DIAGRAM - 11am. 21st June



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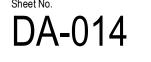
### SHADOW DIAGRAMS

SCALE @ A1

As indicated @ A1

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SHADOW DIAGRAM - 9am. 21st June



SHADOW DIAGRAM - 10am. 21st June



SHADOW DIAGRAM - 1pm. 21st June



SHADOW CAST ON WINDOW AT 9AM ON 21 JUNE (WINTER SOLSTICE) NOTE THAT BY 10AM THE SHADOW IS NOT CAST ON THE WINDOW BY THE PROPOSED BUILDING


SHADOW ON WINDOW At 16a Mona Road at 9am. 21st June



MUNMURRA STREET

SHADOW DIAGRAM - 12 noon 21st June

SHADOW DIAGRAM - 3pm 21st June

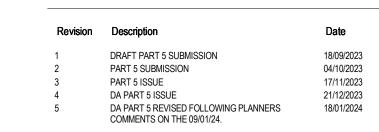

### Part 5 Submission

### **NOTES: DEVELOPMENT APPLICATION**

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### 2. GRAPHIC PRESENTATION

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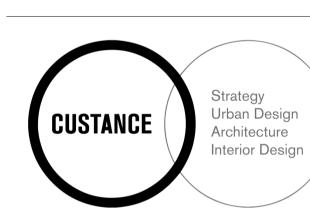
3. EXISTING STRUCTURES AND SERVICES Extent and location of existing and proposed neighbouring structures and services is according to the available survey

### information and will need to be verified on site at later stage. THIS DRAWING IS TO BE PRINTED IN COLOUR

### Consultants

Arborist: Arterra Landscape Architect: Site Image Access Consultant: Ai Access Mechanical: Knox Structural: JN Civil / Stormwater: JN Hydraulic: JN Electrical: JN BASIX / Nathers Certification:

Traffic Consultant:



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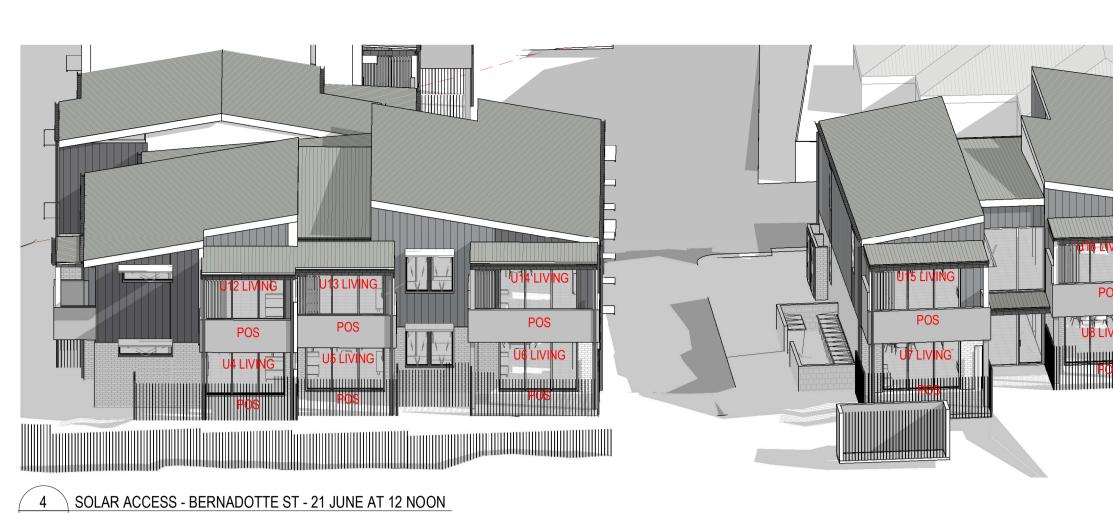
10-14 MUNMURRA RD. & 5 BERNADOTTE ST, RIVERWOOD, NSW 2210 LOTS 57,58,59 & 60 in DP 35818 SENIOR HOUSING DEVELOPMENT


SOLAR ACCESS STUDIES -BERNADOTTE ST

Drawn	Checked	Scale
KL	RW	As indicated @ A1

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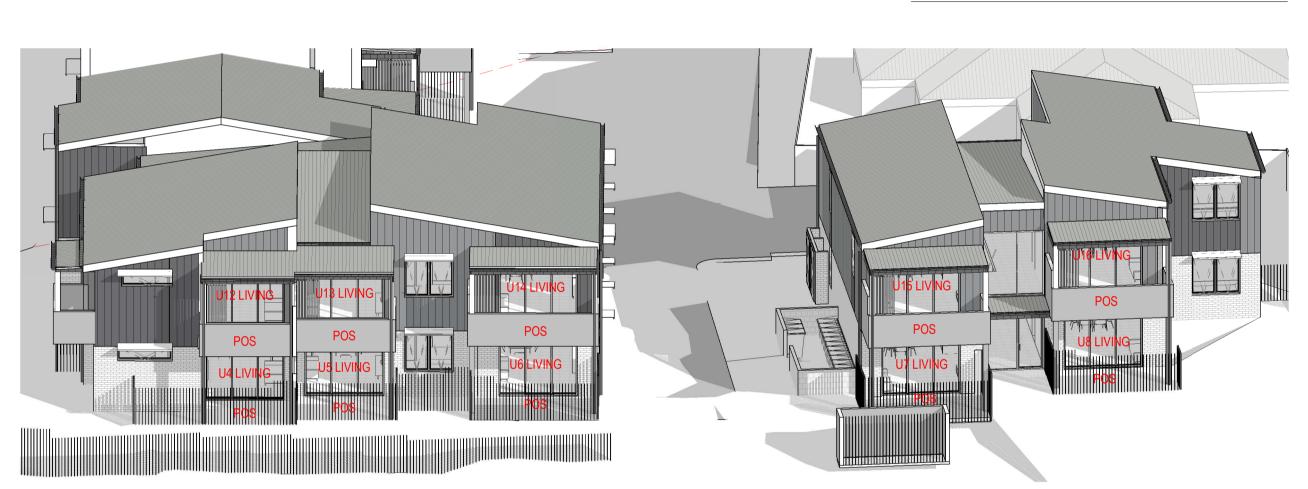




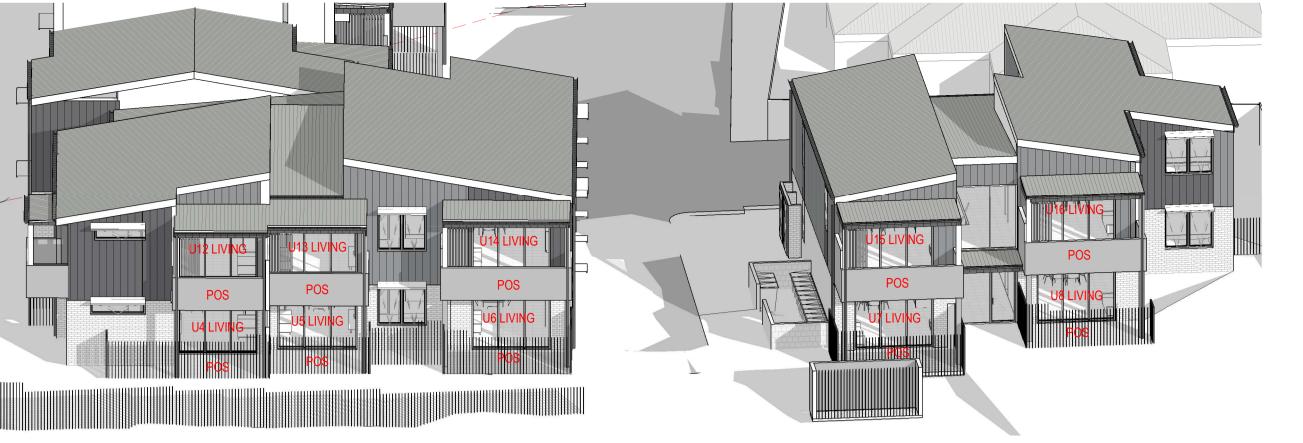

1 SOLAR ACCESS - BERNADOTTE ST - 21 JUNE AT 9AM


		SOLAR ACCES	OTABLE	
UNIT No.	LOUNGE	SOLAR ACCESS	POS	SOLAR ACCESS
UNIT 1	9am - 2pm	5 hours, Complies with SEPP	9am - 2pm	5 hours, Complies wi
UNIT 2	10am - 2pm	4 hours, Complies with SEPP	9am - 2pm	5 hours, Complies wi
UNIT 3	2pm	Non-Compliant	11am - 2pm	3 hours, Complies wi
UNIT 4	9am	Non-Compliant	9am - 11am	2 hours, Complies wi
UNIT 5	9am - 11am	2 hours, Complies with SEPP	9am - 12 noon	3 hours, Complies wi
UNIT 6	9am - 2pm	5 hours, Complies with SEPP	9am - 2pm	5 hours, Complies wi
UNIT 7	9am - 11am	2 hours, Complies with SEPP	9am - 1pm	4 hours, Complies wi
UNIT 8	9am - 2pm	5 hours, Complies with SEPP	9am - 2pm	5 hours, Complies wi
UNIT 9	9am - 2pm	5 hours, Complies with SEPP	9am - 2pm	5 hours, Complies wi
UNIT 10	9am - 2pm	5 hours, Complies with SEPP	9am - 2pm	5 hours, Complies wi
UNIT 11	10am - 2pm	4 hours, Complies with SEPP	11am - 2pm	3 hours, Complies wi
UNIT 12	9am	Non-Compliant	9am - 11am	2 hours, Complies wi
UNIT 13	9am - 11am	2 hours, Complies with SEPP	9am - 12 noon	3 hours, Complies wi
UNIT 14	9am - 2pm	5 hours, Complies with SEPP	9am - 2pm	5 hours, Complies wi
UNIT 15	9am - 11am	2 hours, Complies with SEPP	9am - 1pm	4 hours, Complies wi
UNIT 16	9am - 2pm	5 hours, Complies with SEPP	9am - 2pm	5 hours, Complies wi









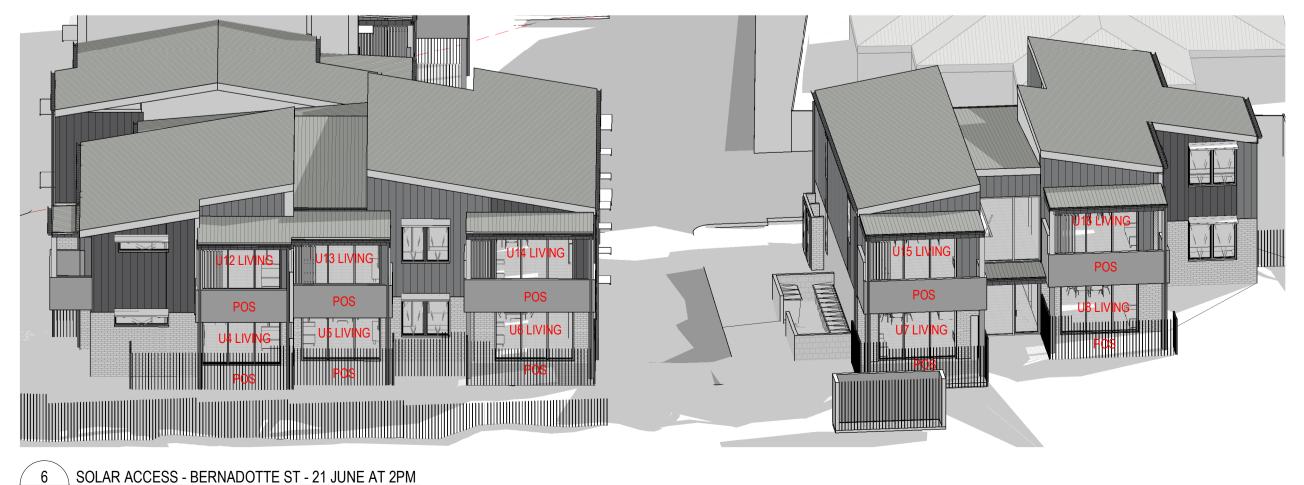

SOLAR ACCESS TABLE

13 of 16 units achieve SEPP requirements for Solar Access, or 81.25% of total development, SEPP requires min 70%.

Note: SEPP Requires: Min 2 hours solar access between 9am and 3pm mid-winter.

5 hours, Complies with SEPP

2 hours, Complies with SEPP 3 hours, Complies with SEPP

5 hours, Complies with SEPP 9am - 2pm

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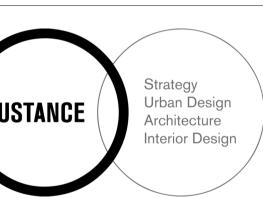
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> THIS DRAWING IS TO BE PRINTED IN COLOUR

Consultants

Traffic Consultant:

Landscape Architect: Site Image Access Consultant: Ai Access Mechanical: Knox Structural: JN Civil / Stormwater: JN Hydraulic: JN Electrical: JN BASIX / Nathers Certification:



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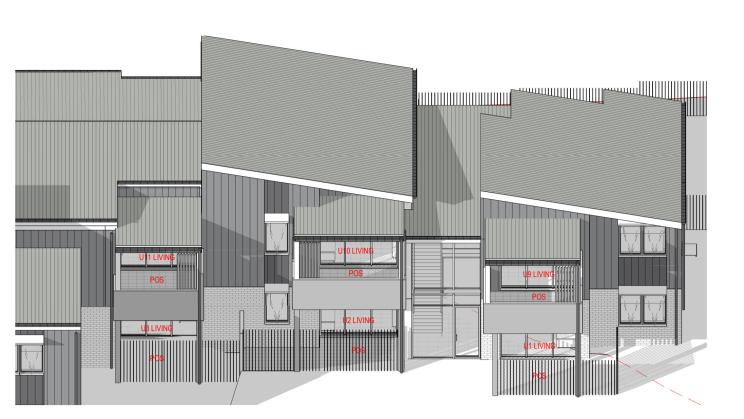
SOLAR ACCESS STUDIES - INTERNAL CARPARK

RW As indicated @ A1

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1 SOLAR ACCESS - CARPARK - 21 JUNE AT 9AM




4 SOLAR ACCESS - CARPARK - 21 JUNE AT 12 NOON



2 SOLAR ACCESS - CARPARK - 21 JUNE AT 10AM

3 SOLAR ACCESS - CARPARK - 21 JUNE AT 11AM

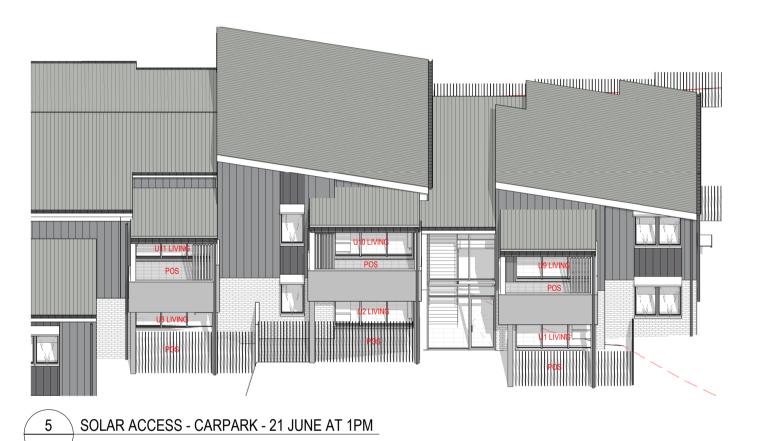





PART 5 ISSUE 17/11/2023 DA PART 5 ISSUE 21/12/2023 DA PART 5 REVISED FOLLOWING PLANNERS COMMENTS ON THE 09/01/24. 18/01/2024

### Part 5 Submission

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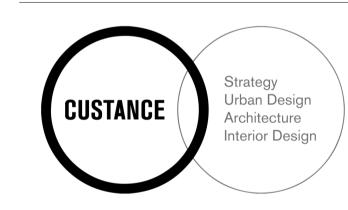
### 3. EXISTING STRUCTURES AND SERVICES Extent and location of existing and proposed neighbouring structures and services is according to the available survey information and will need to be verified on site at later stage.

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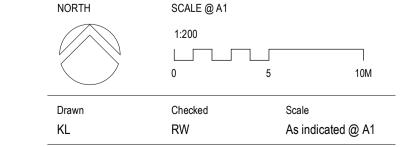
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RIVERWOOD, NSW 2210 LOTS 57,58,59 & 60 in DP 35818 SENIOR HOUSING DEVELOPMENT

10-14 MUNMURRA RD. & 5 BERNADOTTE ST,

# CUT AND FILL DIAGRAMS





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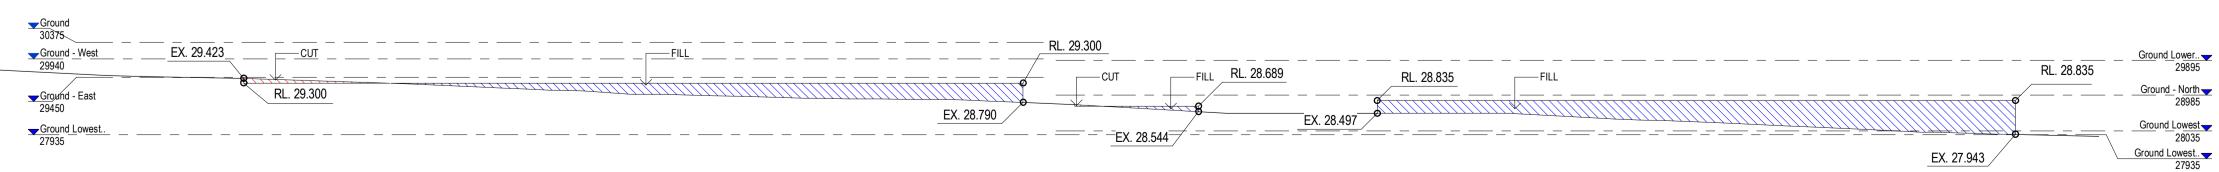



3 CUT AND FILL 2 DA-006 1:100

CUT AND FILL LEGEND




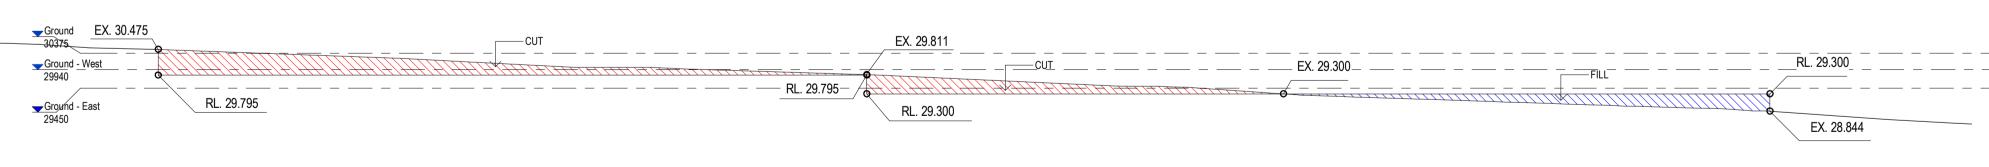

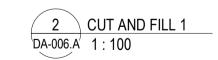

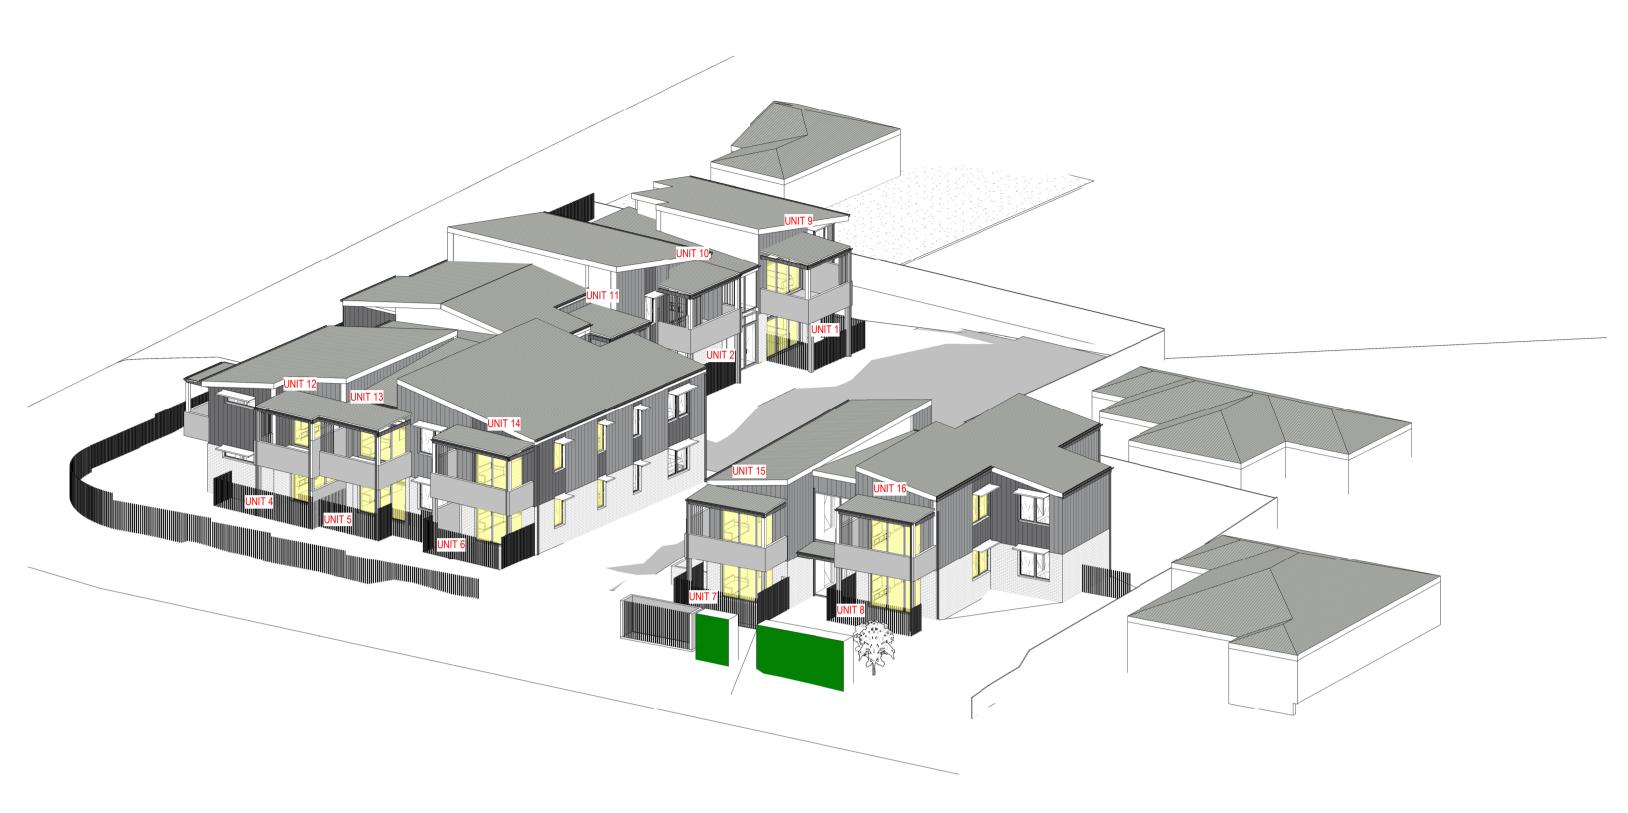

View From The Sun - JUNE 21 9AM

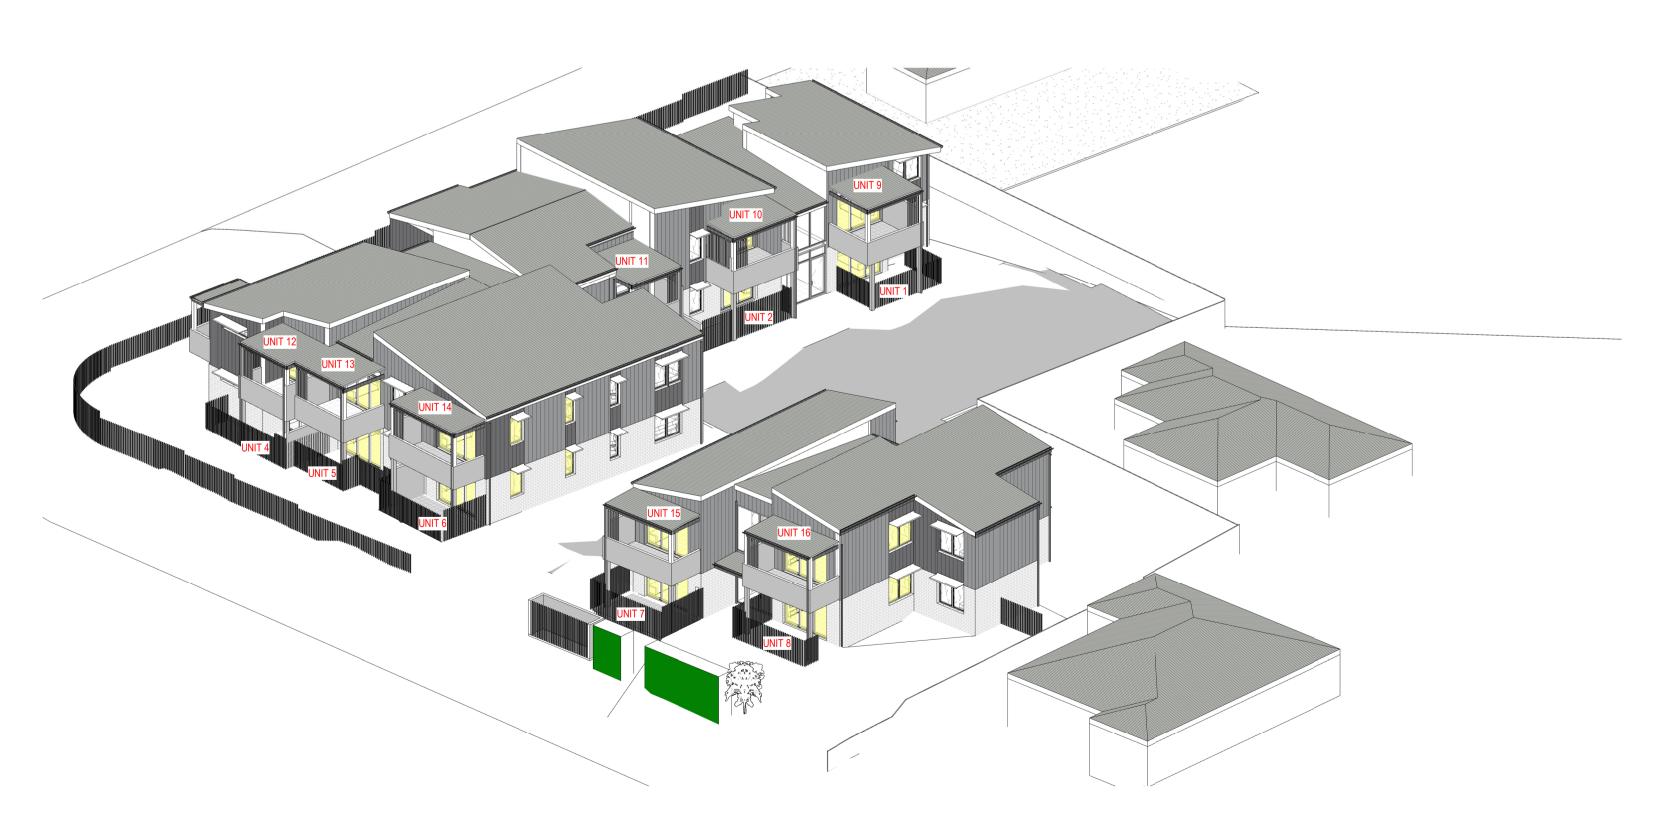

View From The Sun - JUNE 21 10AM



Halada Gil DETERMINED by the NSW Land and Housing Corporation on: 28.06.24

Revision	Description	Date
1	PART 5 ISSUE	17/11/2023
2	DA PART 5 ISSUE	21/12/2023
3	DA PART 5 REVISED FOLLOWING PLANNERS COMMENTS ON THE 09/01/24.	18/01/2024
4	DA PART 5 REVISED FOLLOWING CLIENTS EMAIL ON THE 15/05/24.	17/05/2024

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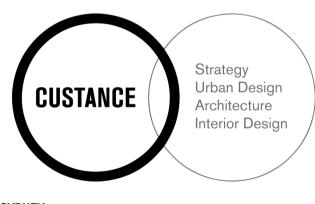
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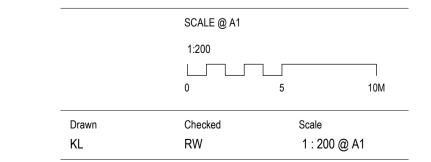


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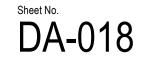
10-14 MUNMURRA RD. & 5 BERNADOTTE ST, RIVERWOOD, NSW 2210 LOTS 57,58,59 & 60 in DP 35818 SENIOR HOUSING DEVELOPMENT

### VIEWS FROM THE SUN - SHEET 1





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View From The Sun - JUNE 21 12PM



Revision	Description	Date
1	PART 5 ISSUE	17/11/2023
2	DA PART 5 ISSUE	21/12/2023
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## Part 5 Submission

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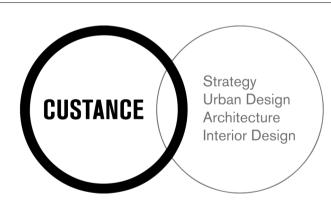
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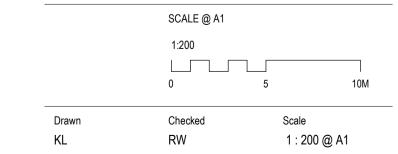
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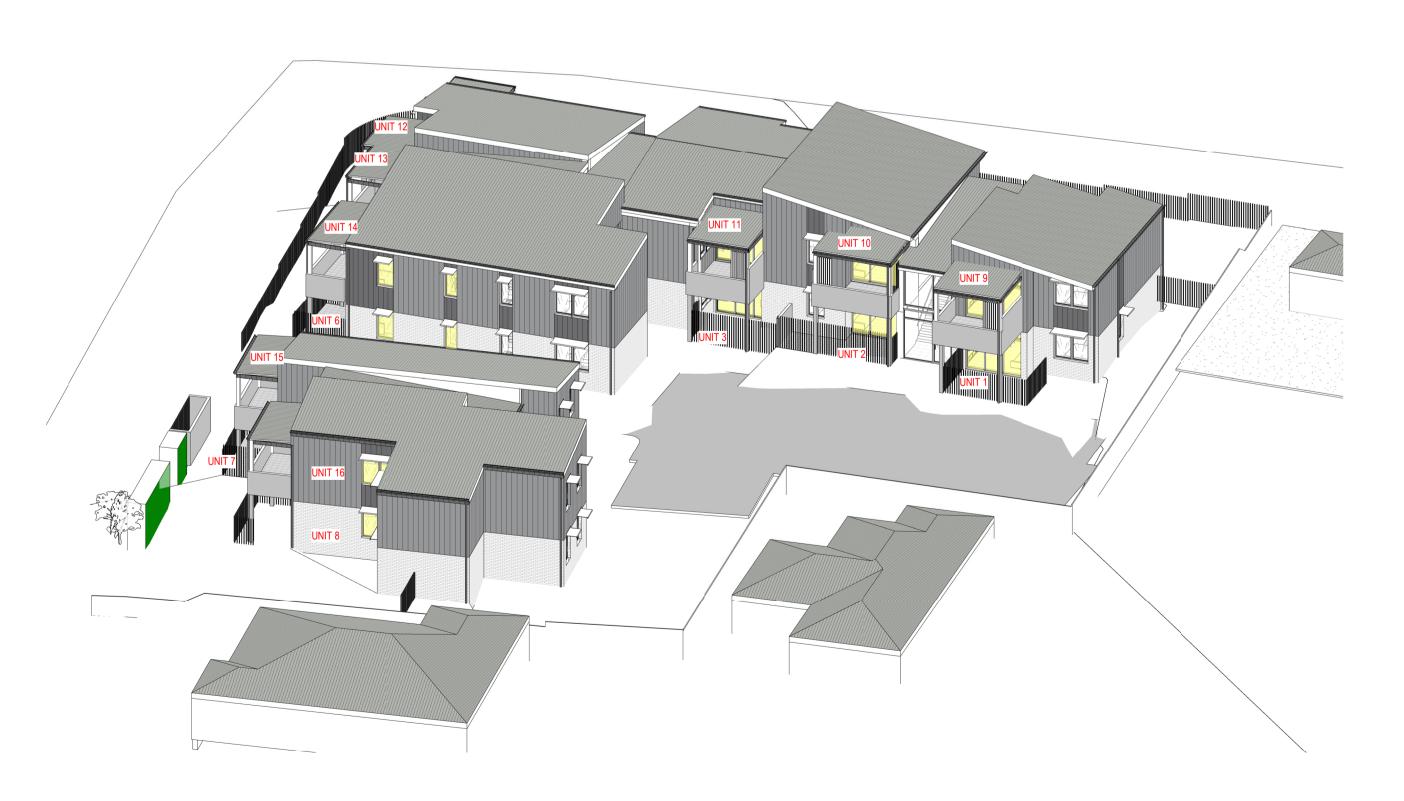
## VIEWS FROM THE SUN - SHEET 2

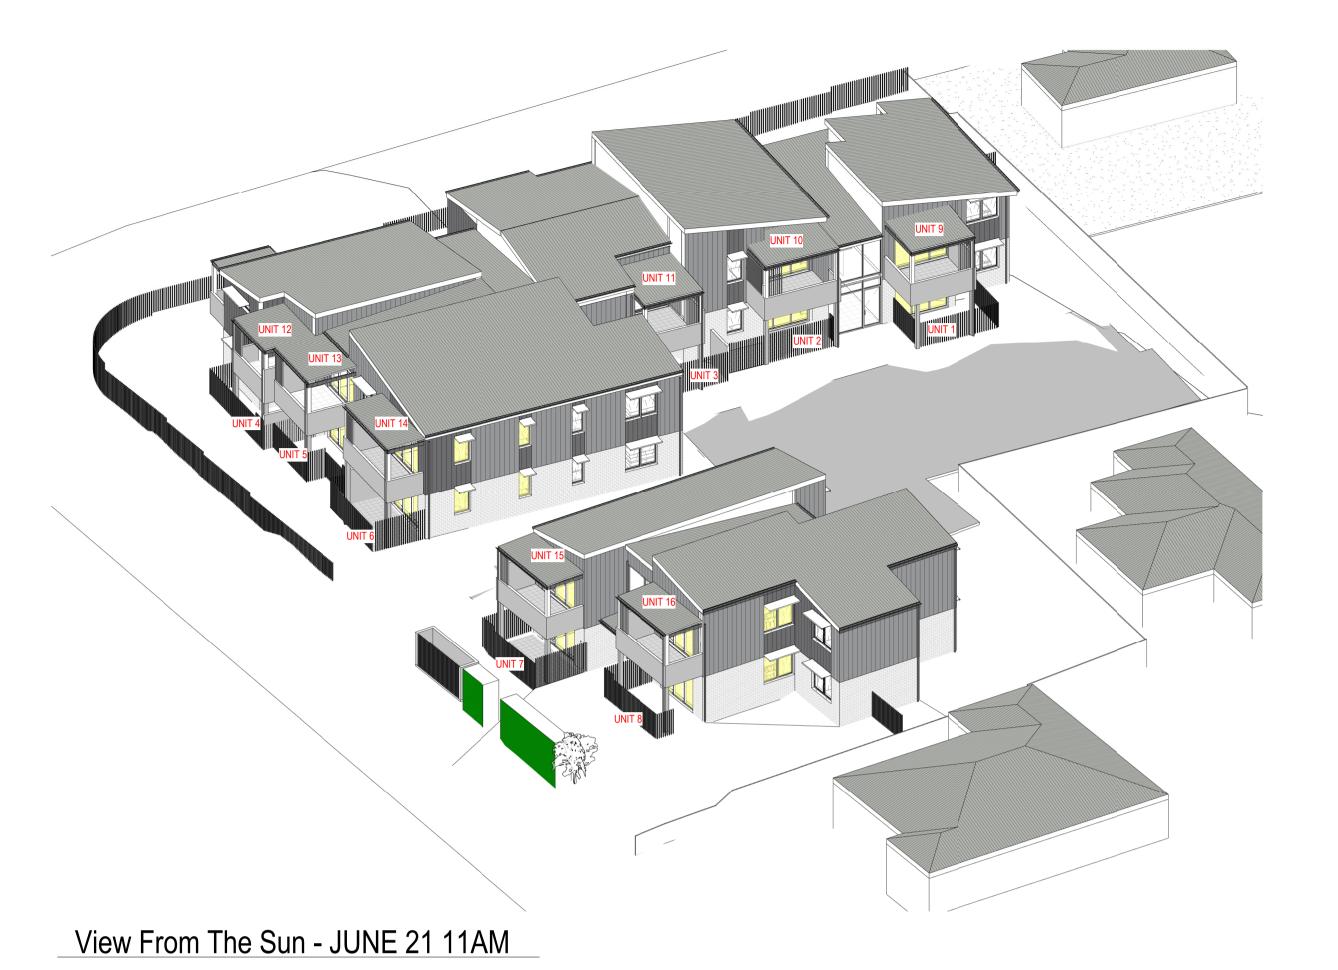
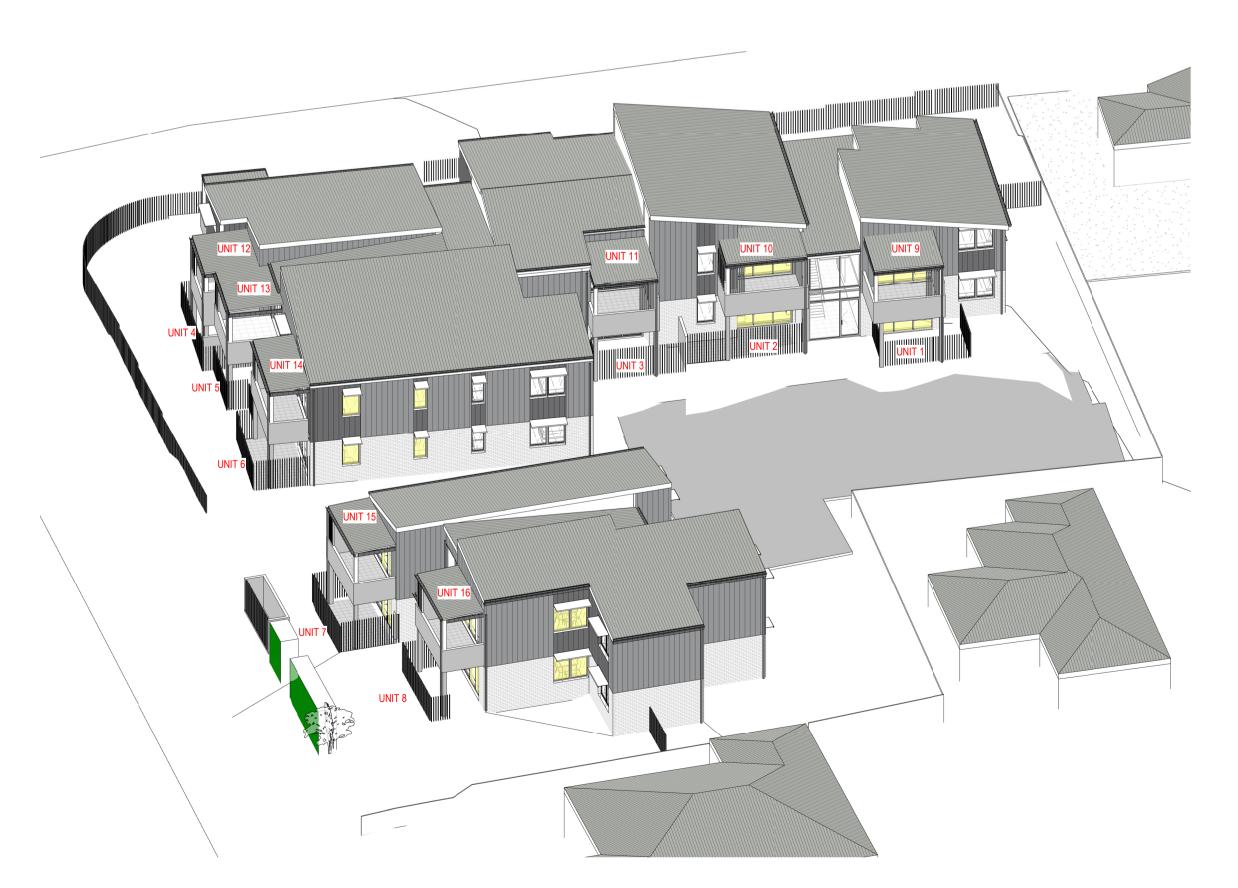
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View From The Sun - JUNE 21 1PM



View From The Sun - JUNE 21 2PM



Revision	Description	Date
1	PART 5 ISSUE	17/11/2023
2	DA PART 5 ISSUE	21/12/2023
3	DA PART 5 REVISED FOLLOWING PLANNERS COMMENTS ON THE 09/01/24.	18/01/2024
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## Part 5 Submission

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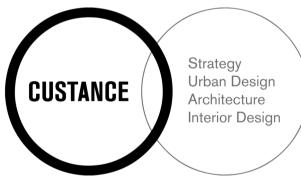
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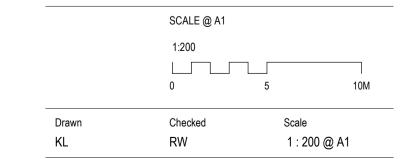


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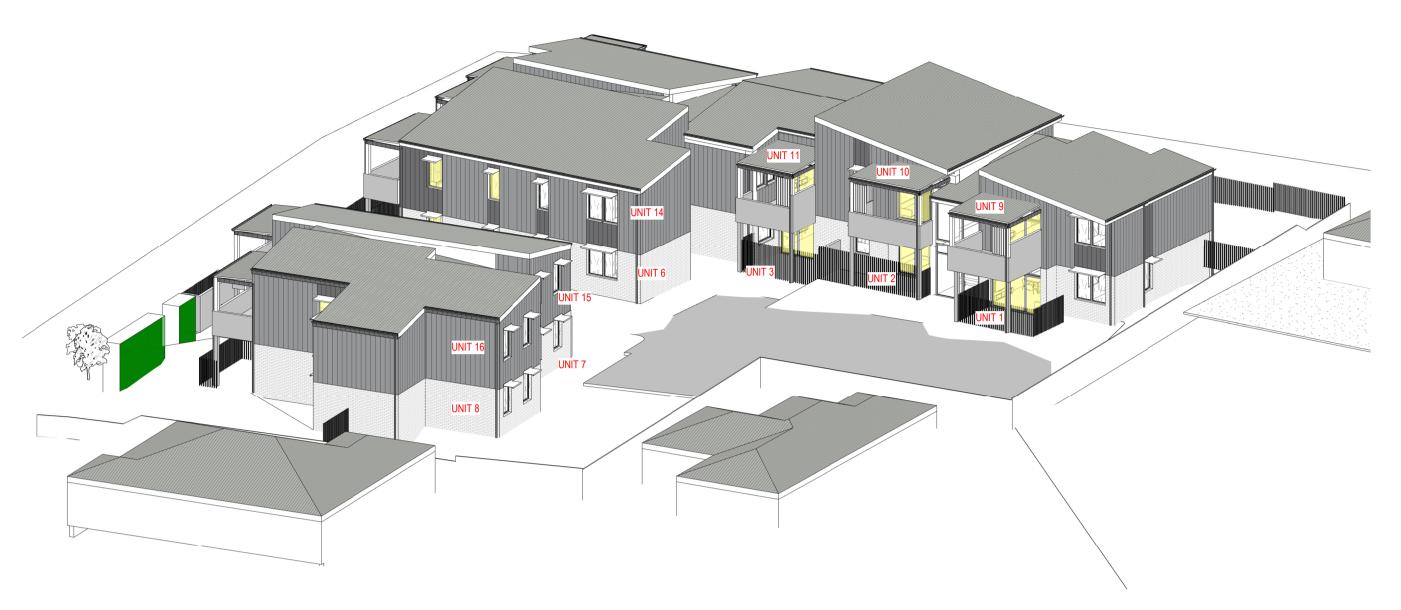
10-14 MUNMURRA RD. & 5 BERNADOTTE ST, RIVERWOOD, NSW 2210 LOTS 57,58,59 & 60 in DP 35818 SENIOR HOUSING DEVELOPMENT

## VIEWS FROM THE SUN - SHEET 3



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View From The Sun - JUNE 21 3PM

Revision	Description	Date
1	PART 5 ISSUE	17/11/2023
2	DA PART 5 ISSUE	21/12/2023
3	DA PART 5 REVISED FOLLOWING PLANNERS COMMENTS ON THE 09/01/24.	18/01/2024
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## SYDNEY


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10-14 MUNMURRA RD. & 5 BERNADOTTE ST, RIVERWOOD, NSW 2210 LOTS 57,58,59 & 60 in DP 35818 SENIOR HOUSING DEVELOPMENT

Sheet Title

## VIEWS FROM THE SUN - SHEET 4



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# 10-14 Munmurra Road & 5 Bernadotte St

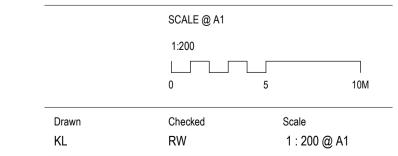Riverwood, NSW, 2210


## DRAWING SCHEDULE

Dwg No.	Drawing Title	Scale
000	Coversheet	N/A
001	Existing Tree Management Plan	1:150 @ A1
100	Landscape Masterplan (Colour)	1:150 @ A1
101	General Arrangement Plan 1	1:100 @ A1
102	General Arrangement Plan 2	1:100 @ A1
201	Planting Plan 1	1:100 @ A1
202	Planting Plan 2	1:100 @ A1
500	Landscape Specification Notes & Planting Schedule	N/A
501	Landscape Details	As Shown @ A1



Site Location Plan




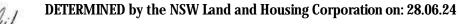

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10-14 Munmurra Rd & 5 Bernadotte St Riverwood, NSW 2210

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## **DEVELOPMENT APPLICATION**

Landscape Coversheet

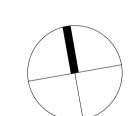
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 25.01.2024

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 19.12.2023

 B
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 BS
 RS
 15.09.2023

 A
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 01.09.2023

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— — Site Boundary

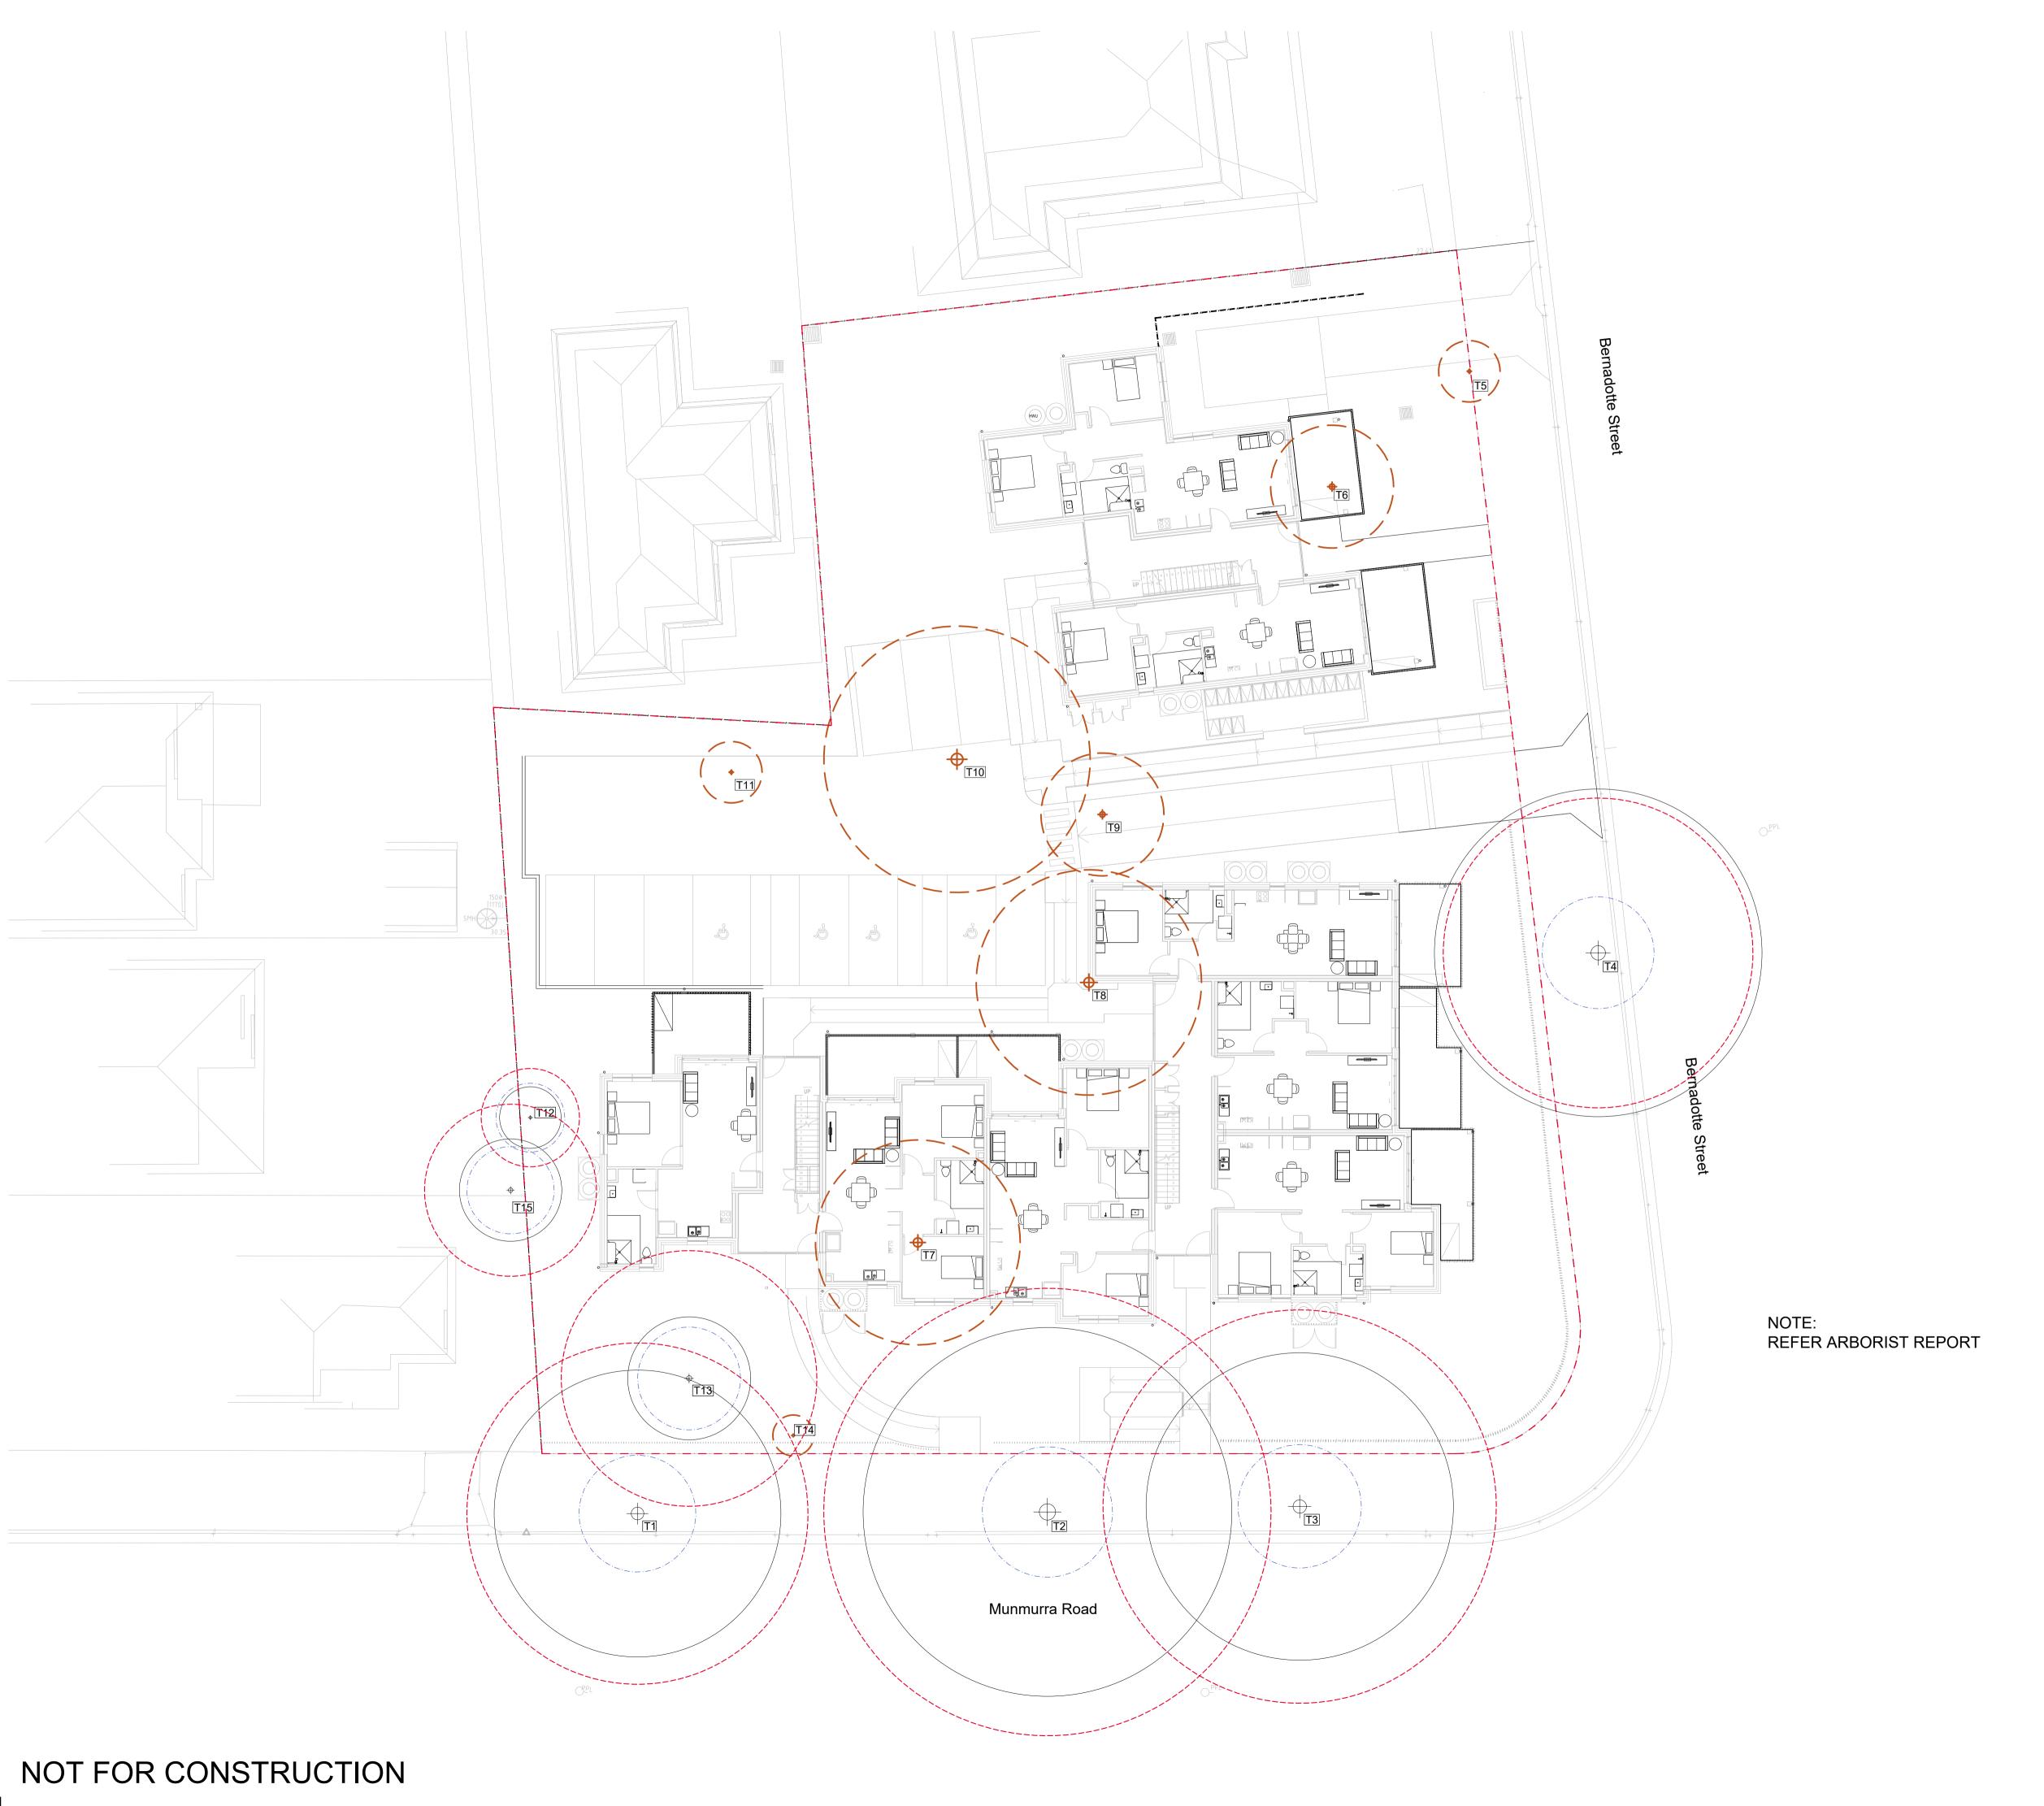TX E

Existing tree to be retained and protected. Tree numbers correlate with Arborist Report; Refer to Arborist Report.




Existing tree to be removed. Tree numbers correlate with Arborist Report



Tree Protection Zone (TPZ)

Structural Root Zone (SRZ)

Key Plan

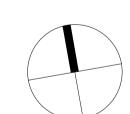

Client

Department of Planning and Environment, Land and Housing Corporation

Proje

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Riverwood, NSW 2210

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## DEVELOPMENT APPLICATION

Drawing Name

Existing Tree Masterplan


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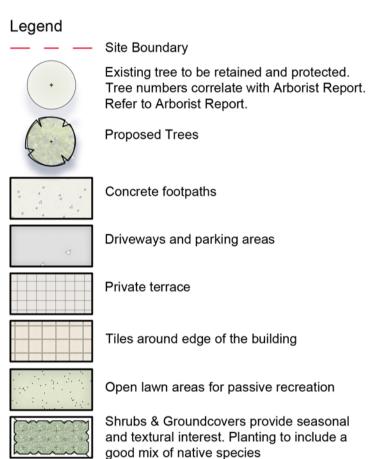




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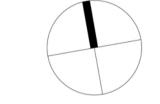
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	Issue for Approval	BS	RS	19.12.2023	
	Issue for Approval	BS	RS	03.11.2023	
	Issue for Approval	BS	RS	15.09.2023	
	Issue for Approval	MJW	RS	01.09.2023	
ıe	Revision Description	Drawn	Check	Date	



Seat with arm and back rests for resting

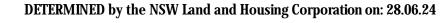1.2m high palisade fence

and relaxing



Department of Planning and Environment, Land and **Housing Corporation** 

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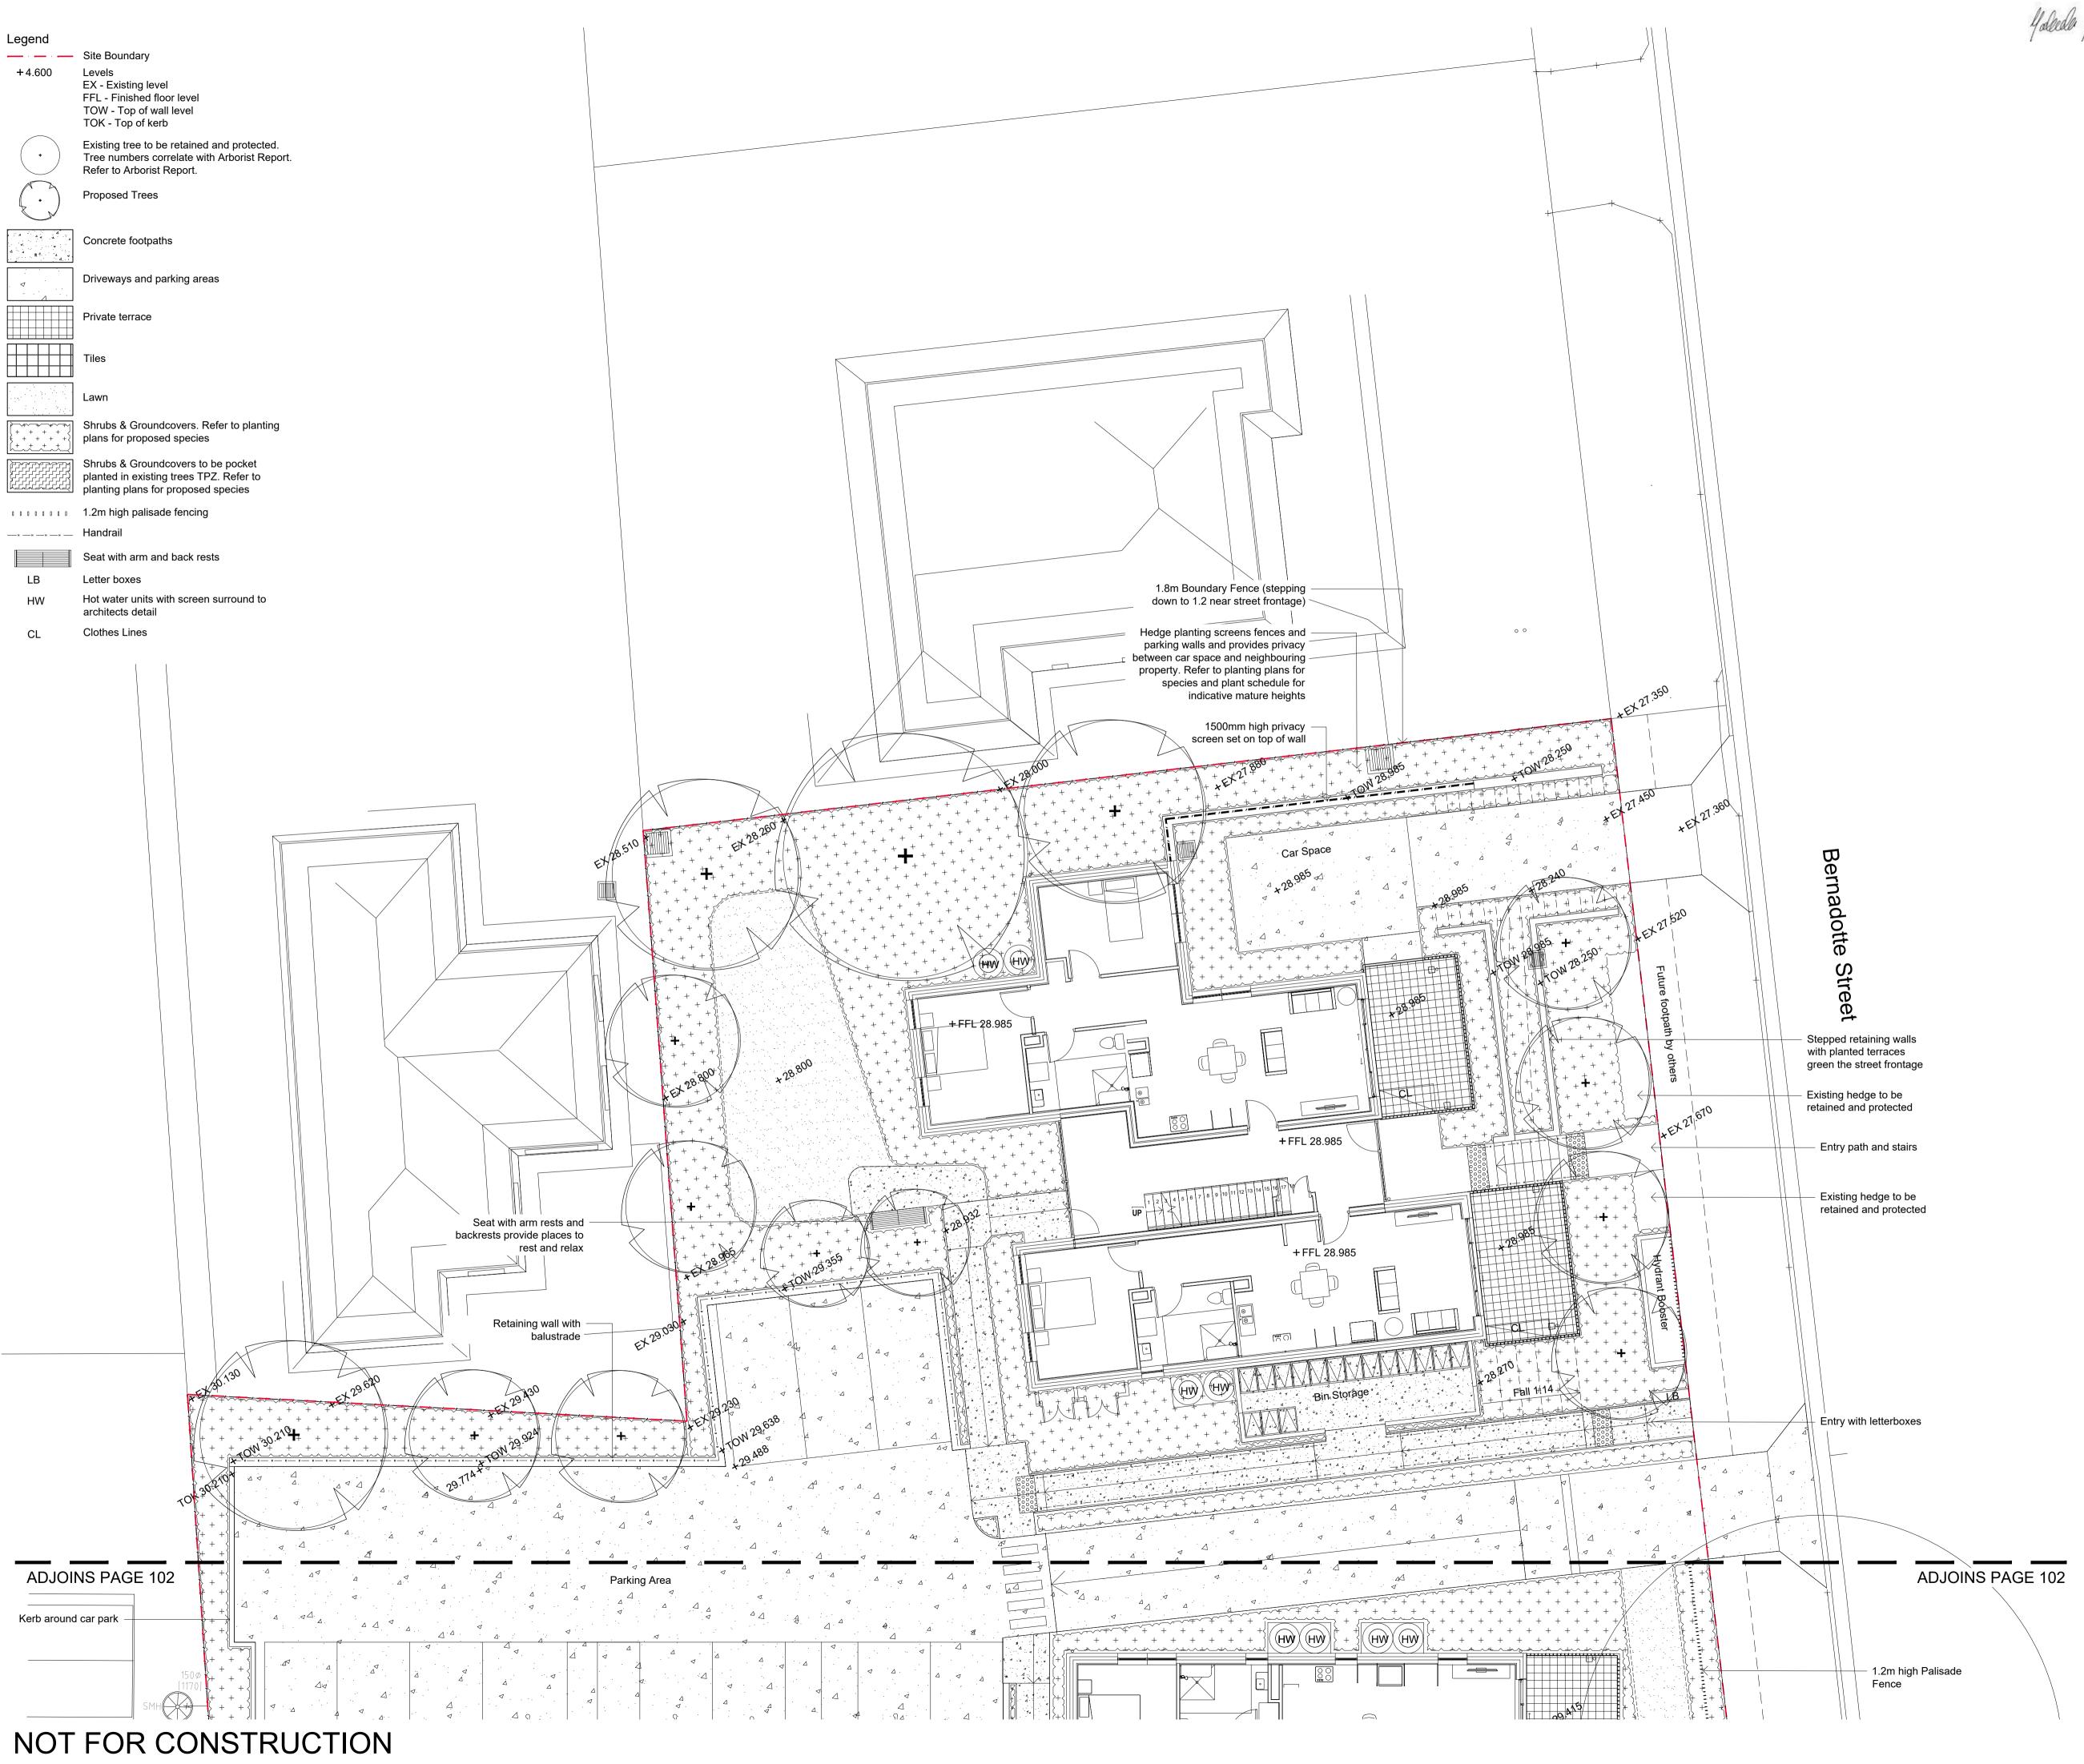
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SITE IMAGE

## DEVELOPMENT APPLICATION

Drawing Name


Landscape Masterplan (Colour)



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D Issue for Approval
C Issue for Approval
B Issue f



Client

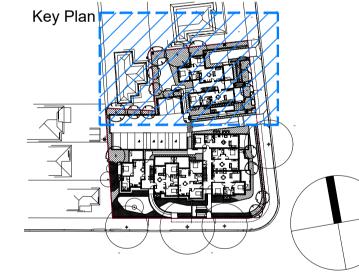Department of Planning and Environment, Land and Housing Corporation

Project

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Riverwood, NSW 2210

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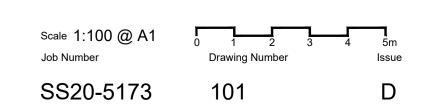



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## DEVELOPMENT APPLICATION

Drawing Name

General Arrangement Plan 1




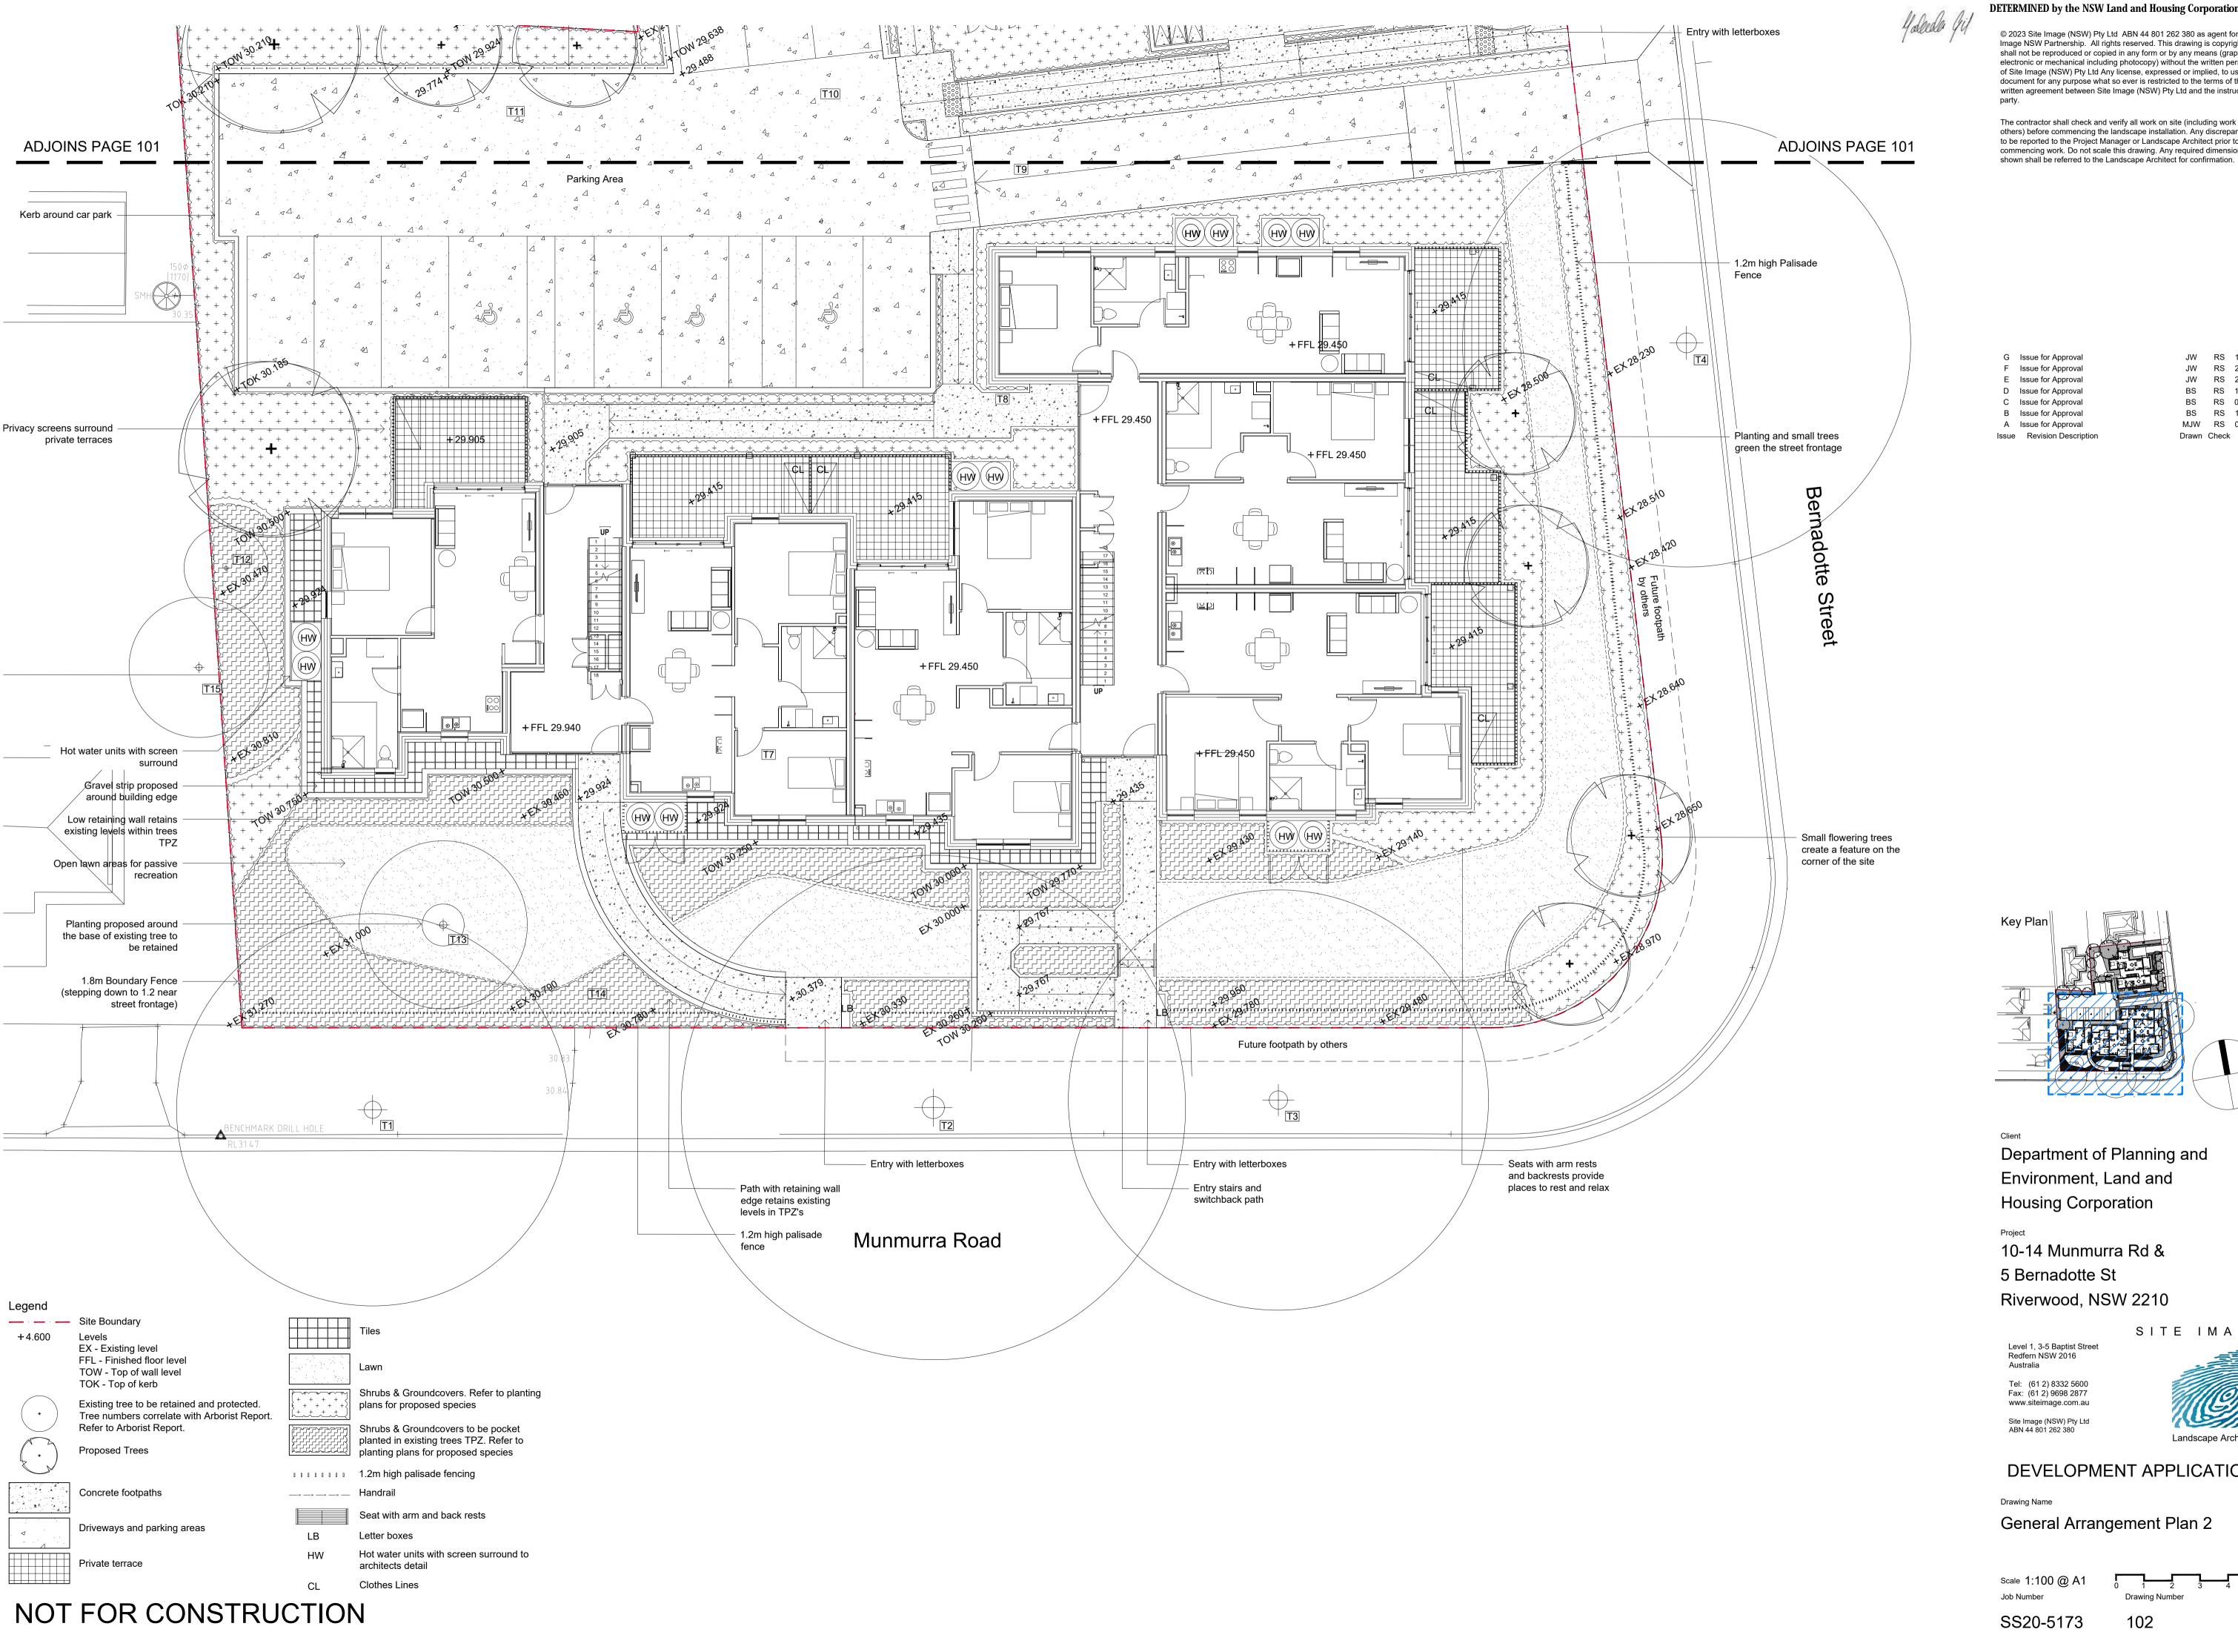

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Department of Planning and Environment, Land and **Housing Corporation** 


5 Bernadotte St

Riverwood, NSW 2210

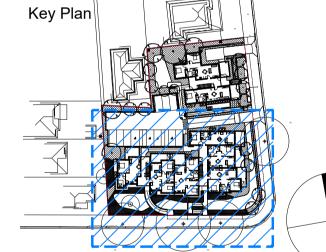

## DEVELOPMENT APPLICATION

Drawing Number 102

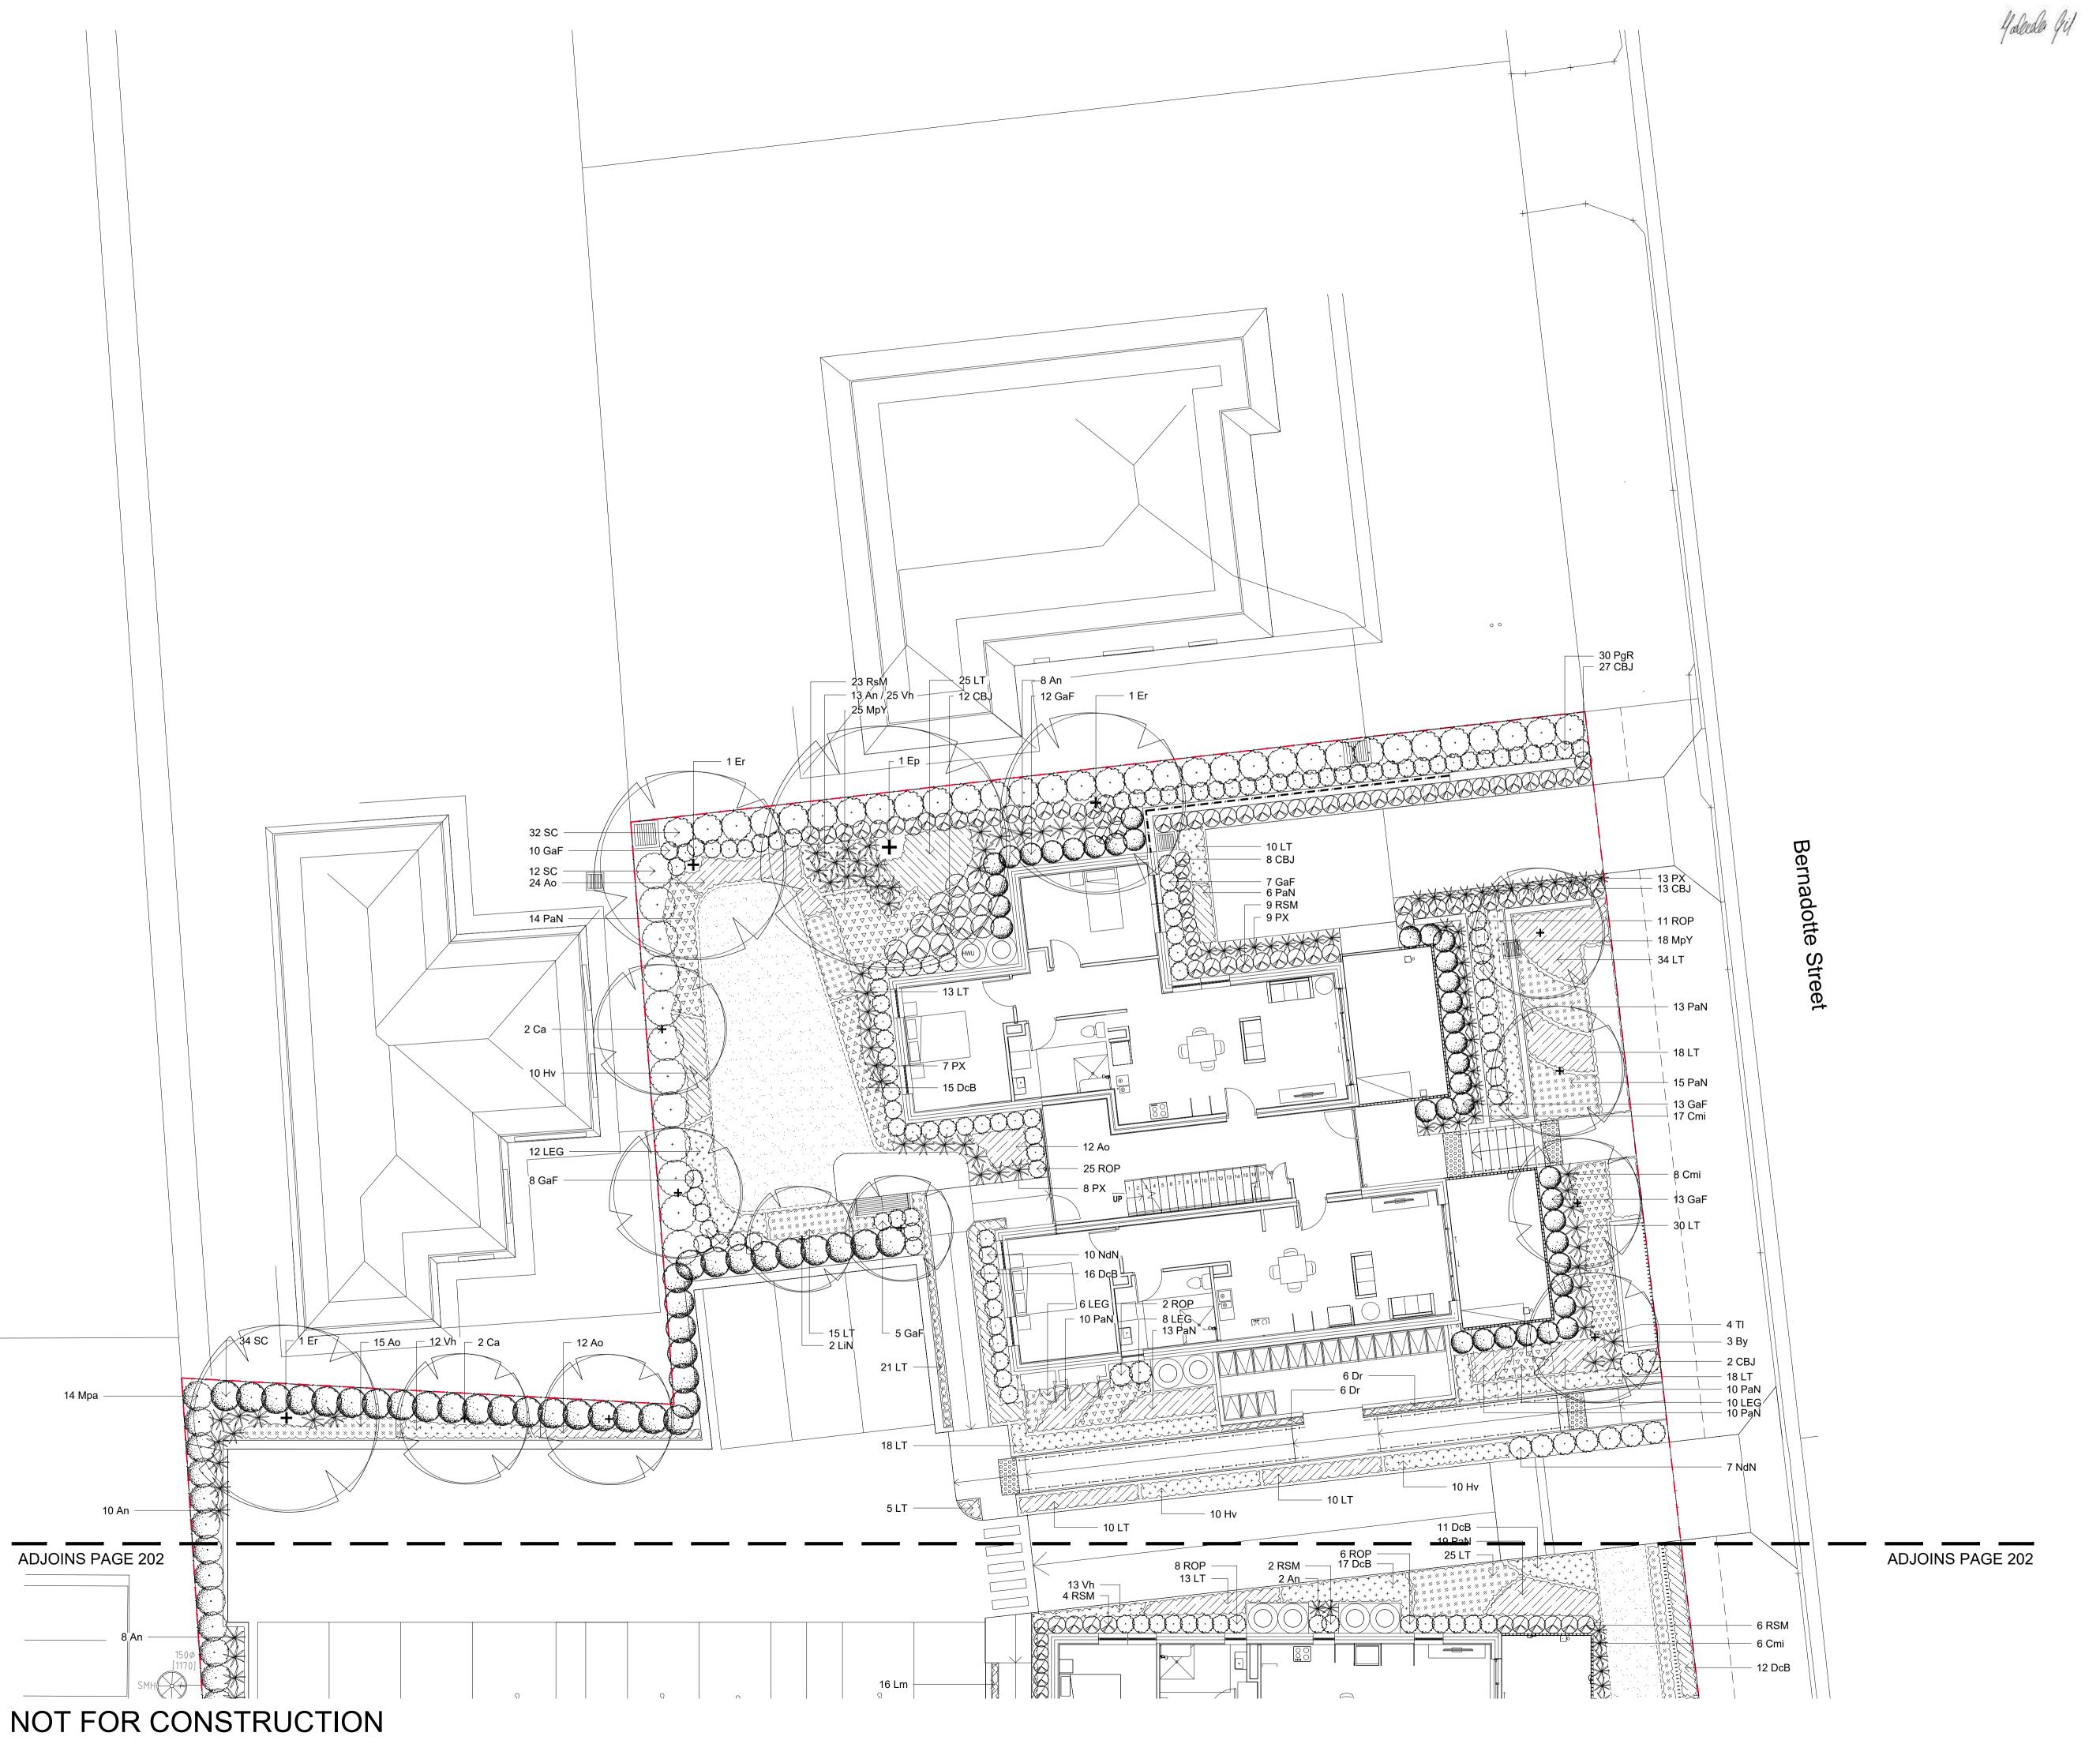

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 Revision Description
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Legend

— Site Boundary

Existing tree to be retained and protected


Tree Protection Zone (TPZ)

+ Proposed frees

Shrubs & Accent

Groundcovers

Law

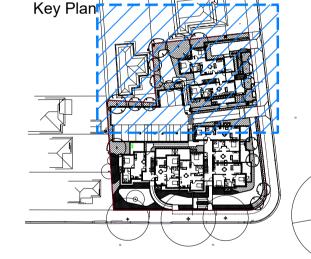

Client

Department of Planning and Environment, Land and Housing Corporation

Project

10-14 Munmurra Rd &5 Bernadotte StRiverwood, NSW 2210

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DEVELOPMENT APPLICATION


Planting Plan 1

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Job Number Drawing Number

SS20-5173

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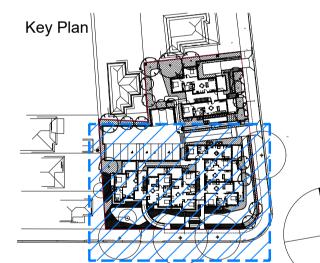
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— — Site Boundary Existing tree to be retained and protected

Tree Protection Zone (TPZ)

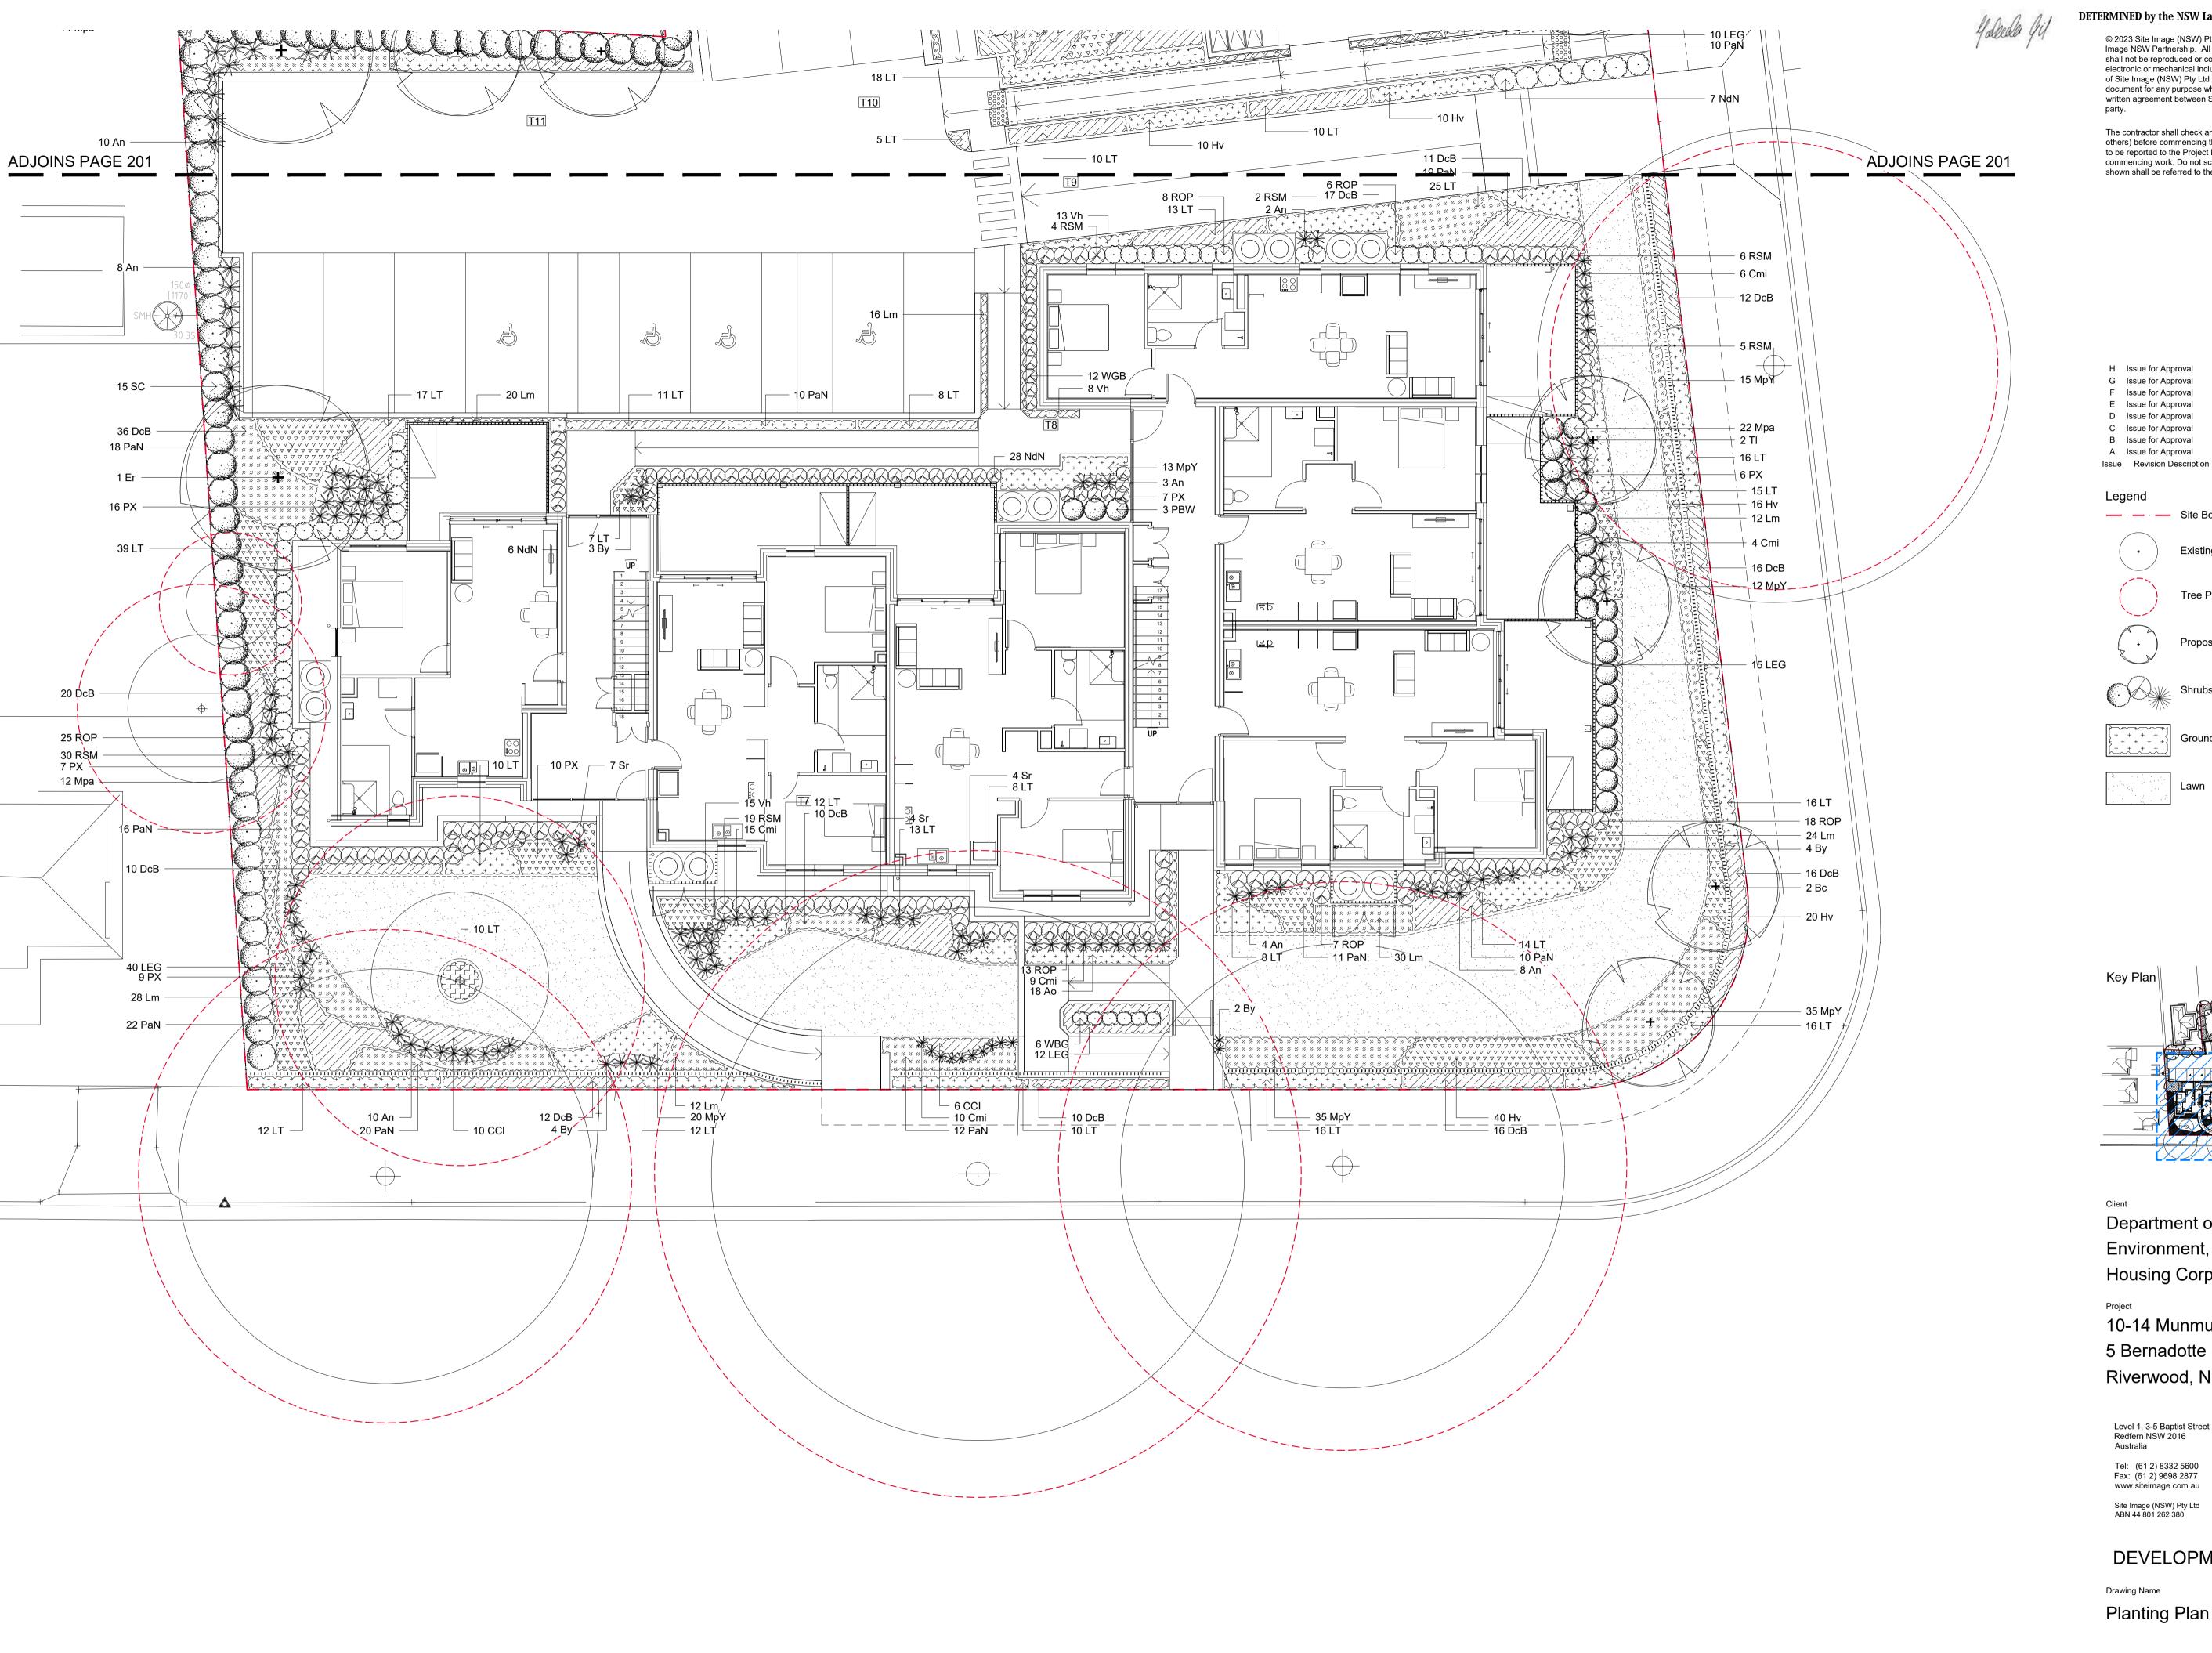Groundcovers



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## DEVELOPMENT APPLICATION

Drawing Name Planting Plan 2

SS20-5173 202

#### **GENERAL NOTES**

#### References

All plans and details included in the project documents shall be read in conjunction with this specification. All structural and civil works components of the landscape design shall be referenced to engineers' details and specifications. Read this specification in conjunction with the plant and materials schedules on the drawings. If in doubt about any detail or if conflicts are found in the documents, seek advice.

#### **Workmanship and Materials**

The whole of the landscape works shall be carried out by a competent, trained and qualified landscape contractor who is experienced in horticultural practices, landscape construction and planting techniques. The landscape contractor shall hold a current Building Contractors License and/or be a financial member of LNA Landscape Association NSW & ACT or equivalent organisations in other states.

#### **EXISTING TREES AND SHRUBS**

#### Trees and Shrubs to be Retained and Protected

Identify and mark trees and shrubs to be retained using a suitable non-injurious, easily visible and removable means of identification. Protect from damage the trees and shrubs to be retained, including those beyond the site area, both above and below the ground. If a tree becomes damaged during the works or it is proposed to perform work on a tree, give written notice immediately and obtain instructions.

#### **Work near Trees and Shrubs**

Keep the area of the drip-line free from construction material and debris. Do not place bulk materials and harmful materials under foliage canopies or near trees. Do not place spoil from excavations against tree trunks. Prevent wind-blown building materials, such as cement, from covering trees and other plants. Do not remove topsoil from, or add topsoil to, the area within the drip-line of trees.

#### **EARTHWORKS**

#### **Excavation, Trimming and Filling**

Except as otherwise noted in the contract, bulk excavation is excluded from the landscape works. After the completion of bulk excavation by others, trim and fill the excavated ground surfaces to achieve design levels to accommodate finish materials as detailed. Prepare the sub-grade surface as required for the various finished ground treatments.

#### Sub-soil Drainage

Keep the excavated works drained and free of standing water. Allow to supply and install sub-soil drainage pipes as required for the new works to ensure that all gardens are well drained. Connect the sub-soil drainage pipes to the nearest downstream stormwater pits. Include pipe filter socks and course sharp aggregate backfilling of trenches.

#### **HARDWORKS**

#### Furniture, Handrails, Balustrades

Supply and install the scheduled items in accordance with the manufacturer's recommendations, as detailed and in the locations shown on plan. Provide all footings and fixings required for the items to be stable and in accordance with applicable codes and standards.

#### Garden Walls, Fences, Steps, TGSI and Edging

Construct garden walls, fences, steps, TGSI and edging as shown on plan, as detailed and of the material scheduled. Provide footings, step nosings, tactile surfaces to comply with standards and applicable legislation. Refer to engineer's details for structural retaining walls, heavy duty slabs, concrete stairs, concrete strength, reinforcing and joint placement.

#### **Continuous, Unit and Loose Pavement**

Install the scheduled material pavement to the locations shown on plan. Ensure that all subgrade/subsurface works are complete prior to commencing paving. Confer with the engineer to ensure the structural integrity of the subgrade. Ensure that the base course under paved surfaces is a continuous plane offering a constant depth of bedding material not exceeding 50mm.

### **SOFTWORKS**

## **Soil Testing**

Where site soil is to be retrieved from and stored for reuse on site, undertake at least two (2) soil tests, in locations as advised by the Project Manager. Provide results and recommendations regarding soil additives for the benefit of healthy plant growth and to adjust the soil components to achieve an appropriate planting medium for successful plant development.

#### Subsoil

Excavate and/or fill all garden beds to bring the top of subsoil to at least 300mm below finished design soil levels. Excavate all turf areas to bring the subsoil to at least 100mm below finished design levels. In all areas shape the subsoil to fall to subsoil drains where applicable. Do not excavate within the drip line of trees and shrubs to be retained. Cultivate or rip the subsoil to a further depth of 100mm before placing top soil. Remove stones of size exceeding 25mm, clods of earth exceeding 50mm, and

weeds, rubbish or other deleterious material brought to the surface during cultivation. Do not disturb services or existing tree roots. If necessary cultivate these areas by hand. During cultivation, thoroughly mix in materials required to be incorporated into the subsoil, as recommended in the soil testing results and to manufacturer's recommendations. Trim the surface to design levels again after cultivation.

#### Topsoil

Import topsoil for the garden and turf areas, unless the topsoil can be provided from material recovered from the site, as recommended in the soil testing results. Spread the topsoil on the prepared subsoil and grade evenly, compact lightly and uniformly in 150mm layers. Avoid differential subsidence and excess compaction and produce a finished topsoil surface which has the following characteristics:

- Finished to design levels, allowing for mulch or turf, which is to finish flush with adjoining hard surfaces such as paths and edges;
- Smooth and free from inorganic matter, stones or clods
- Graded to drain freely, without ponding, to catchment and/or sub-soil drains;
- Graded evenly to adjoining surfaces; and
- Ready for planting.

Provide, in accordance with AS 4454, well rotted vegetative material or animal manure, free from harmful chemicals, inorganic matter, grass, weeds and the reproductive parts of unwanted plants.

#### Fertiliser

Provide proprietary fertilisers, delivered to the site in sealed containers marked to show manufacturer or vendor, weight, fertiliser type, N:P:K ratio, recommended uses, application rates and safety procedures. Apply appropriate fertiliser suited to the provenance of plants (indigenous or exotic) included in the design.

#### **Plants**

- Supply plants in accordance with the landscape design drawings and schedules, which have the following characteristics:
- Large healthy root systems, with no evidence of root curl, restriction or damage;
- Vigorous, well established, free from disease and pests,
- of good form consistent with the species/variety; Hardened off, not soft or forced, and suitable for planting in the natural climatic conditions prevailing at the site in
- full sun, partial shade or full shade conditions; • Grown in final containers for not less than twelve weeks:
- Trees, unless required to be multi-stemmed, shall have a
- single leading shoot; and Containers shall be free from weeds and of appropriate size in relation to the specified plant size.

#### Plant Installation

Following excavation of the planting hole, place and spread 15gms of wetting agent pre-mixed with one (1) litre of water. Place the plant correctly orientated to north or for best presentation. Backfill the planting holes with specified topsoil mixture. Lightly tamp and water to eliminate air pockets. Ensure that the backfill soil is not placed over the top of the root ball and that the root ball is not higher than the soil in which it is planted. Apply fertiliser, as specified around the plants in the soil at the time of planting.

#### **Embankment Stabilisation**

Where necessary and shown on the drawings prevent soil erosion or soil movement by stabilising embankments as follows. As a minimum this should be on slopes steeper than or equal to 1:3 gradient. Stabilise embankments using biodegradable fibre reinforced heavy weight jute fabric. Lay fabric from top to bottom of slope. Install in accordance with manufacturer's specification, including 300 x 300mm anchor trench at top and bottom of slope, backfilled with soil over the fabric and compacted into the trenches. Using U-shaped galvanised steel pegs at 1000 mm centres generally and 250mm centres at edge overlaps, secure the fabric to the prepared soil surface. Plant through the fabric after it is installed.

#### **Root Barrier**

Supply and install root control barriers to all new tree plantings adjacent to walls, paths, kerbs and all service trenches, where their proximity poses a threat to the stability of the built infrastructure. Install in accordance with manufacturer's recommendations.

#### Mulch

Unless noted otherwise, mulch shall be approved proprietary recycled wood fibre or pine bark material. Place mulch in all garden beds to a depth of 75mm after all specified plants are installed. Keep mulch clear of all plant stems and rake to an even plane, flush with the surrounding surfaces evenly graded between design surface levels. Over fill to allow mulch to settle to the specified depth.

#### Stakes and Ties

Stakes shall be durable hardwood, straight, free of knots and twists, pointed at one end, in the following quantities and sizes for each of the various plant pot sizes:

- Plants (>25 lt): 1 off 38 x 38 x 1200mm; Semi-advanced plants (>75 lt): 2 off 50x50x 1800mm;
- Advanced (>100 lt): 3 off 50 x 50 x 2400mm. Turf

Turf shall be delivered to site as 25mm minimum thick cut rolls. Obtain turf from a specialist grower of cultivated turf.

Turf shall have an even thickness, free from weeds and other foreign matter. Deliver turf to the site within 24 hours of being cut and lay it within 24 hours of delivery. Prevent it form drying out between cutting and laying. Lay the turf in the following manner:

- In stretcher pattern, joints staggered and close butted;
- Parallel long sides of level areas, with contours on
- To finish flush, after lightly tamping, with adjacent finished surfaces and design levels.

#### IRRIGATION

#### All proposed landscape areas shall be irrigated.

The irrigation system shall be an automatic permanent system, with an irrigation controller self operated via a soil moisture sensor. The system shall be calibrated to deliver the optimum rate and volume of water appropriate to the type of plants in the design. The system shall be adjustable and fully serviceable. The layout of the entire irrigation system shall focus on delivering the required amount of water to maintain healthy and vigorous growth. The irrigation system shall be such that, component theft, vandalism, over-spray and wetting of paths shall be reduced to a minimum or completely eliminated by the use of drip, pop-up sprinklers and judiciously placed fixed spray emitters. Generally do not use fine mist emitters that provide a drifting mist that may wet paths and the buildings unless specifically required by the design.

#### LANDSCAPE MAINTENANCE

The Landscape Contractor shall rectify defects during installation and that become apparent in the works under normal use for the duration of the contract Defects Liability Period. Unless contracted otherwise, the Landscape Contractor shall maintain the contract areas by the implementation of industry accepted horticultural practices for 52 weeks from Practical Completion of the works. The landscape maintenance works shall include, but not be limited to:

- Replacing failed plants;
- Pruning;
- Insect and pest control:
- Fertilising:
- Maintaining and removing stakes and ties;
- Maintaining mulch;
- Mowing and top dressing;
- Irrigation and watering;
- Erosion control; and
- Weeding and rubbish removal.

#### Maintenance Log Book

Implement and keep a maintenance log book recording when and what maintenance work has been undertaken and what materials, actions and decisions have been used, implemented and concluded to keep the landscape always looking its best. Enter data daily and review information every 2 weeks. Observe trends and develop a maintenance regime around seasonal and observed event occurrences.

#### **Maintenance Activities**

During the defects maintenance period schedule the following activities to occur on a timely basis.

- Plant replacement Replace plants that have failed to mature, die or are damaged. Replacement plants shall be in a similar size and quality and identical species or variety to the plant that has failed. Replacement of plants shall be at the cost of the landscape contractor unless advised otherwise. If the cause of the failure is due to a controllable situation then correct the situation prior to replacing plants. Observe and replace failed plants within 2 weeks of observation.
- **Pruning** Prune dead wood, broken limbs, dead or infected foliage and as needed to develop strong, healthy plants to achieve the shape and form expected of the plant type. Observe daily and prune plants on a needs
- Insect, disease and pest control Avoid spraying: o if ever possible:
- o in wet weather or if wet weather is imminent;
- if target plants are still wet after rain;
- in windy weather; and

 if non-target species are too close. Immediately report to the Project Manager any evidence of intensive weed infestation, insect attack or disease amongst plant material. Submit all proposals to apply chemicals and obtain approval before starting this work. When approved, spray with herbicide, insecticide, fungicide as appropriate in accordance with the manufacturers' recommendations. Observe daily and act as necessary to control any infestation or disease. Record in the logbook all relevant details of spraying activities including:

- OProduct brand / manufacturer's name.
- Chemical / product name,
- Chemical contents,

of fertilising including:

- Application quantity and rate, Date of application and location,
- Results of application, and Use approval authority.
- Fertilising Fertilise gardens with a proprietary slow release fertiliser applied in accordance with the manufacturer's directions and recommendations. Apply 6-12 monthly. Record in the logbook all relevant details
- OProduct brand / manufacturer's name,
- Fertiliser / product name,

 Application quantity and rate, and Date of application and location.

- Stakes and ties Adjust and replace as required to ensure plants remain correctly staked. Remove those not required at the end of the planting establishment period (Defects Liability Period). Inspect and act at least every
- Maintaining mulch Maintain the surface in a clean, tidy and weed free condition and reinstate the mulch as necessary to ensure correct depth as specified. Observe weekly and replenish mulch as required.
- Mowing and top dressing Mow the turf to maintain a grass height of between 30-50mm. Do not remove more than one third of the grass height at any one time. Remove grass clippings from the site after each mowing. Top dress to a maximum of 10mm to fill depressions and hollows in the surface. Mow weekly/fortnightly in warmer months. Mow monthly or as required in cooler months. Top dress at approximately 6 monthly intervals.
- Irrigation and watering Maintain the irrigation system to sure that each individual plant receives the required amount of water to maintain healthy and vigorous growth. Adjust and calibrate as required. Provide additional watering, if necessary but inspect irrigation weekly and make repairs as necessary.
- Erosion control Where necessary, maintain the erosion control fabric in a tidy and weed free condition and reinstate as necessary to ensure control measures are effective where deemed necessary. Inspect every 2 weeks and act to repair any damage as soon as possible.
- Weeding and rubbish removal During the plant establishment period remove by hand, rubbish and weed growth that may occur or re-occur throughout all planted, mulched and paved areas. The contractor shall target weeds that are capable of producing a major infestation of unwanted plants by seed distribution. Whenever possible, time weed removal to precede flowering and seed set. Constant observation and removal of weeds is

Acmena smithii

Backhousia citriodora

Cupaniosis anacardioides

Lagerstroemia indica 'Natchez'

Tristaniopsis laurina 'Luscious'

Elaeocarpus reticulatus

|Eucalyptus piperita

Asplenium nidus

Murraya paniculata

Philodendron 'Xanadu'

| Photinia glabra 'Rubens'

Strelitzia reginae

|Syzygium 'Cascade'

Agapanthus orientalis

Casuarina 'Cousin It"

Dianella caerulea 'Breeze'

Liriope 'Evergreen Giant'

Hardenbergia violacea 'Meena

Myoporum parvifolium 'Yareena'

|Pennisetum alopercuroides 'Nafray'

|Clivia miniata

Dichondra repens

Liriope muscari

Lomandra 'Tanika'

Viola hederacea

Beschorneria yuccoides

Callistemon 'Better John'

| Gardenia augusta 'Florida'

Nandina domestica 'Nana'

| Phormium tenax 'Bronze Warrior'

Rhaphiolepis indica 'Oriental Pearl

Rhaphiolepis indica 'Snow Maiden'

Westringia fruticosa 'Blue Gem'

Westringia fruticosa 'Grey Box'

Symbol

Asm

Bm

Ca

Er

Еp

LiN

ΤI

An

**CBJ** 

GaF

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MpY

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Vh

**GROUNDCOVERS AND GRASSES** 

SHRUBS & ACCENTS

**TREES** 

Native

10-14 Munmurra Road & 5 Bernadotte Street, Riverwood - Plant Schedule

**Common Name** 

Lemon Scented Myrtle

Lilly Pilly

Tuckeroo

Blueberry Ash

Crepe Myrtle

Birds Nest Fern

Orange Jasmine

**Dwarf Photinia** 

Indian Hawthorn

Indian Hawthorn

Bird Of Paradise

Coastal Rosemary

Coastal Rosemary

Agapanthus Blue

Cousin It She Oak

Dianella Breeze

Happy Wanderer

Lomandra Tanika

Creeping Boobialla

Nafray Pennisetum

Kidney Weed

Giant Liriope

Native Violet

Liriope

**Bush Lily** 

Dwarf Sacred Bamboo

Bronze Warrior NZ Flax

Pink Flowering Lilly Pilly

Dwarf Philodendron

Mexican Lily

Bottlebrush

Gardenia

Water Gum

Sydney Peppermint

**Botanic Name** 

DETERMINED by the NSW Land and Housing Corporation on: 28.06.24

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The contractor shall check and verify all work on site (including work by others) before commencing the landscape installation. Any discrepancies are to be reported to the Project Manager or Landscape Architect prior to commencing work. Do not scale this drawing. Any required dimensions not shown shall be referred to the Landscape Architect for confirmation.

3	Issue for Approval	JW	RS	21.05.2024	
:	Issue for Approval	JW	RS	25.01.2024	
	Issue for Approval	BS	RS	19.12.2023	
)	Issue for Approval	BS	RS	03.11.2023	
)	Issue for Approval	BS	RS	27.09.2023	
3	Issue for Approval	BS	RS	15.09.2023	
١	Issue for Approval	MJW	RS	01.09.2023	
ue	Revision Description	Drawn	Check	Date	

G Issue for Approval

Pot size | Quantity

0

4

2

6

66

16

62

68

48

51

92

3

30

115

98

11

93

6

12

81

16

69

217

12

106

103

142

535

173

229

108

100L

45L

100L

100L

100L

100L

100L

300mm

200mm

150mm

200mm

150mm

Mature

 $H \times W (m)$ 

8 x 2

 $3 \times 2$ 

7 x 5

12 x 5

15 x 12

 $6 \times 3$ 

8 x 4

 $0.8 \times 0.8$ 

1.2 x 1.5

1 x 1

 $1.5 \times 1.5$ 

3 x 2

 $0.6 \times 0.8$ 

 $0.6 \times 0.6$ 

1.5 x 1.5

 $3 \times 1.5$ 

1 x 1

 $0.8 \times 0.8$ 

1.2 x 1.5

 $3 \times 2$ 

1 x 1

 $0.5 \times 0.5$ 

 $0.5 \times 0.5$ 

 $0.5 \times 1.0$ 

 $0.5 \times 0.6$ 

 $0.6 \times 0.6$ 

 $0.1 \times 1$ 

 $0.4 \times 2$ 

 $0.6 \times 0.6$ 

 $0.3 \times 0.3$ 

 $0.5 \times 0.5$ 

 $0.2 \times 1.5$ 

 $0.6 \times 0.6$ 

 $0.1 \times 0.3$ 

Department of Planning and Environment, Land and Housing Corporation

10-14 Munmurra Rd & 5 Bernadotte St Riverwood, NSW 2210

SITE IMAGE Level 1, 3-5 Baptist Street Redfern NSW 2016 Australia Tel: (61 2) 8332 5600

Landscape Architects

DEVELOPMENT APPLICATION

Fax: (61 2) 9698 2877

www.siteimage.com.au

Site Image (NSW) Pty Ltd

Landscape Specification Notes & Planting Schedule


Scale n/a Job Number

SS20-5173


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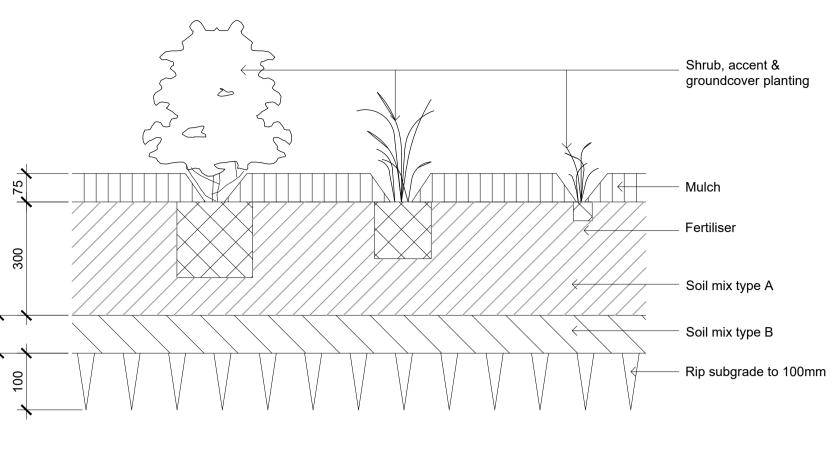
500

NOT FOR CONSTRUCTION

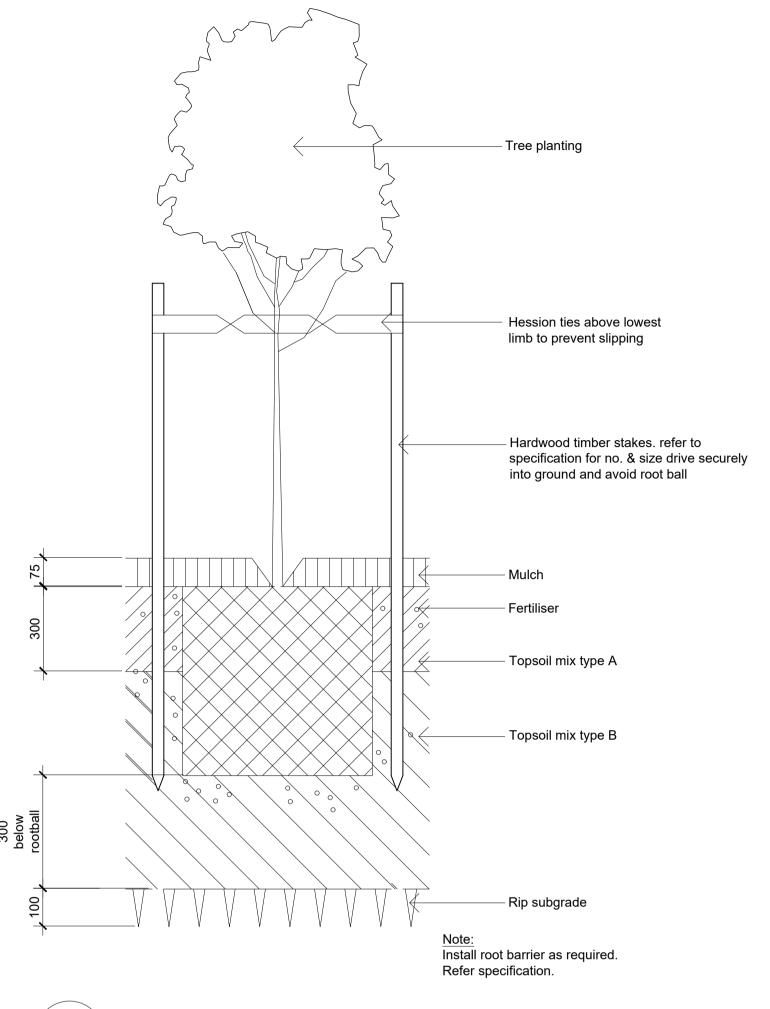


01 Tree Planting on Grade
501 1:10



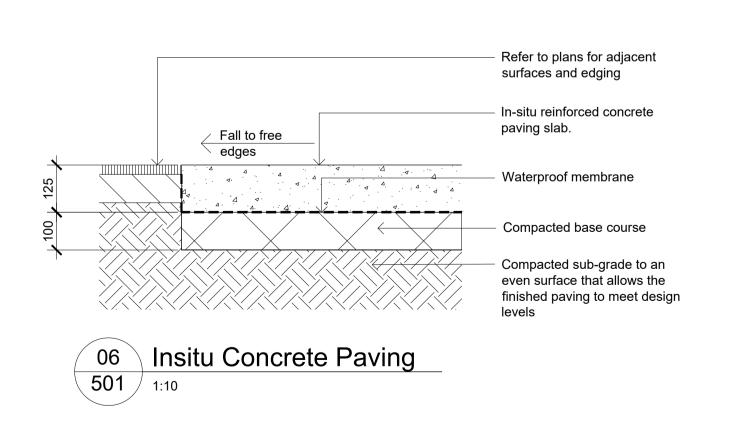


Shrub, Accent & Groundcover Planting on Grade

501 1:10

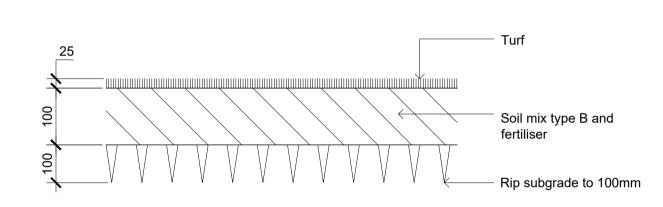

04 Turf on Grade 501 1:10

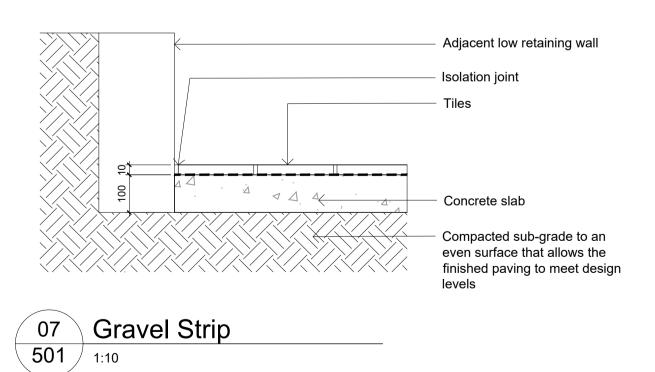



## DETERMINED by the NSW Land and Housing Corporation on: 28.06.24

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B Issue for Approval A Issue for Approval Issue Revision Description

BS RS 03.11.2023 MJW RS 01.09.2023 Drawn Check Date

O3 Pocket Planting in existing trees TPZ

2

Shrub, accent &

Mulch


Existing soil

Soil type A

groundcover planting

Planting hole 2 x depth

and width of rootball

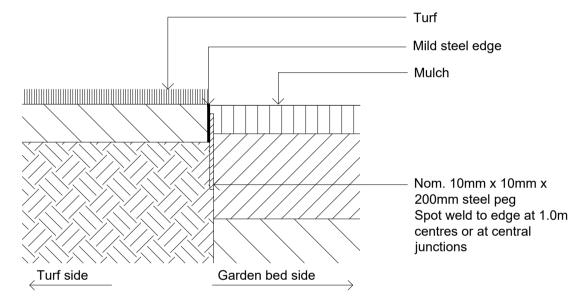

7501 Typical Mild Steel Edge

Department of Planning and Environment, Land and **Housing Corporation** 

10-14 Munmurra Rd & 5 Bernadotte St

Riverwood, NSW 2210

SITE IMAGE

Level 1, 3-5 Baptist Street Redfern NSW 2016 Australia Tel: (61 2) 8332 5600

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## DEVELOPMENT APPLICATION

**Drawing Name** Landscape Details

Scale as shown @ A1

Job Number Drawing Number

501

SS20-5173

NOT FOR CONSTRUCTION

### **NOTES:**

TOTAL = 2494.1 m2 IMPERVIOUS = 1505.9 m2 (60.4%) PERVIOUS = 988.2m2 (39.6%)

OSD SIZING BASED ON GEORGES RIVER COUNCIL STORMWATER MANAGEMENT POLICY 2021 TABLE 3: SSR = 51.4 m3 PSD = 45.4 L/s CAN HAVE UP TO 20% OFFSET FOR OSD STORAGE FOR RWT RE-USE USAGE

1% AEP FLOOD LEVEL (TAILWATER) - RL 27.38

#### OSD 1:

TOTAL AREA = 1803.8 m2 (72.3%)

SSR = 37.2 m3

PSD = 32.8 L/s

BYPASS = 141.3 m2 (0% IMPERVIOUS)


BYPASS PSD = 5.6 L/s

REMAINING OSD 1 PSD = 27.2 L/s

### **OSD 2**:

TOTAL AREA = 690.3 m2 (27.7%) SSR = 14.2 m3 PSD = 12.6 L/s BYPASS = 125.4 m2 (28.7% IMPERVIOUS) BYPASS PSD = 4.8 L/s REMAINING OSD 1 PSD = 7.8 L/s

HAVE 27.7% OF OSD STORAGE BELOW 1% AEP FLOOD LINE (DROWNED ORIFICE). THIS IS BELOW THE 30% AS OUTLINED IN GEORGES RIVER COUNCIL STORMWATER MANAGEMENT POLICY 2021 SECTION 4.13

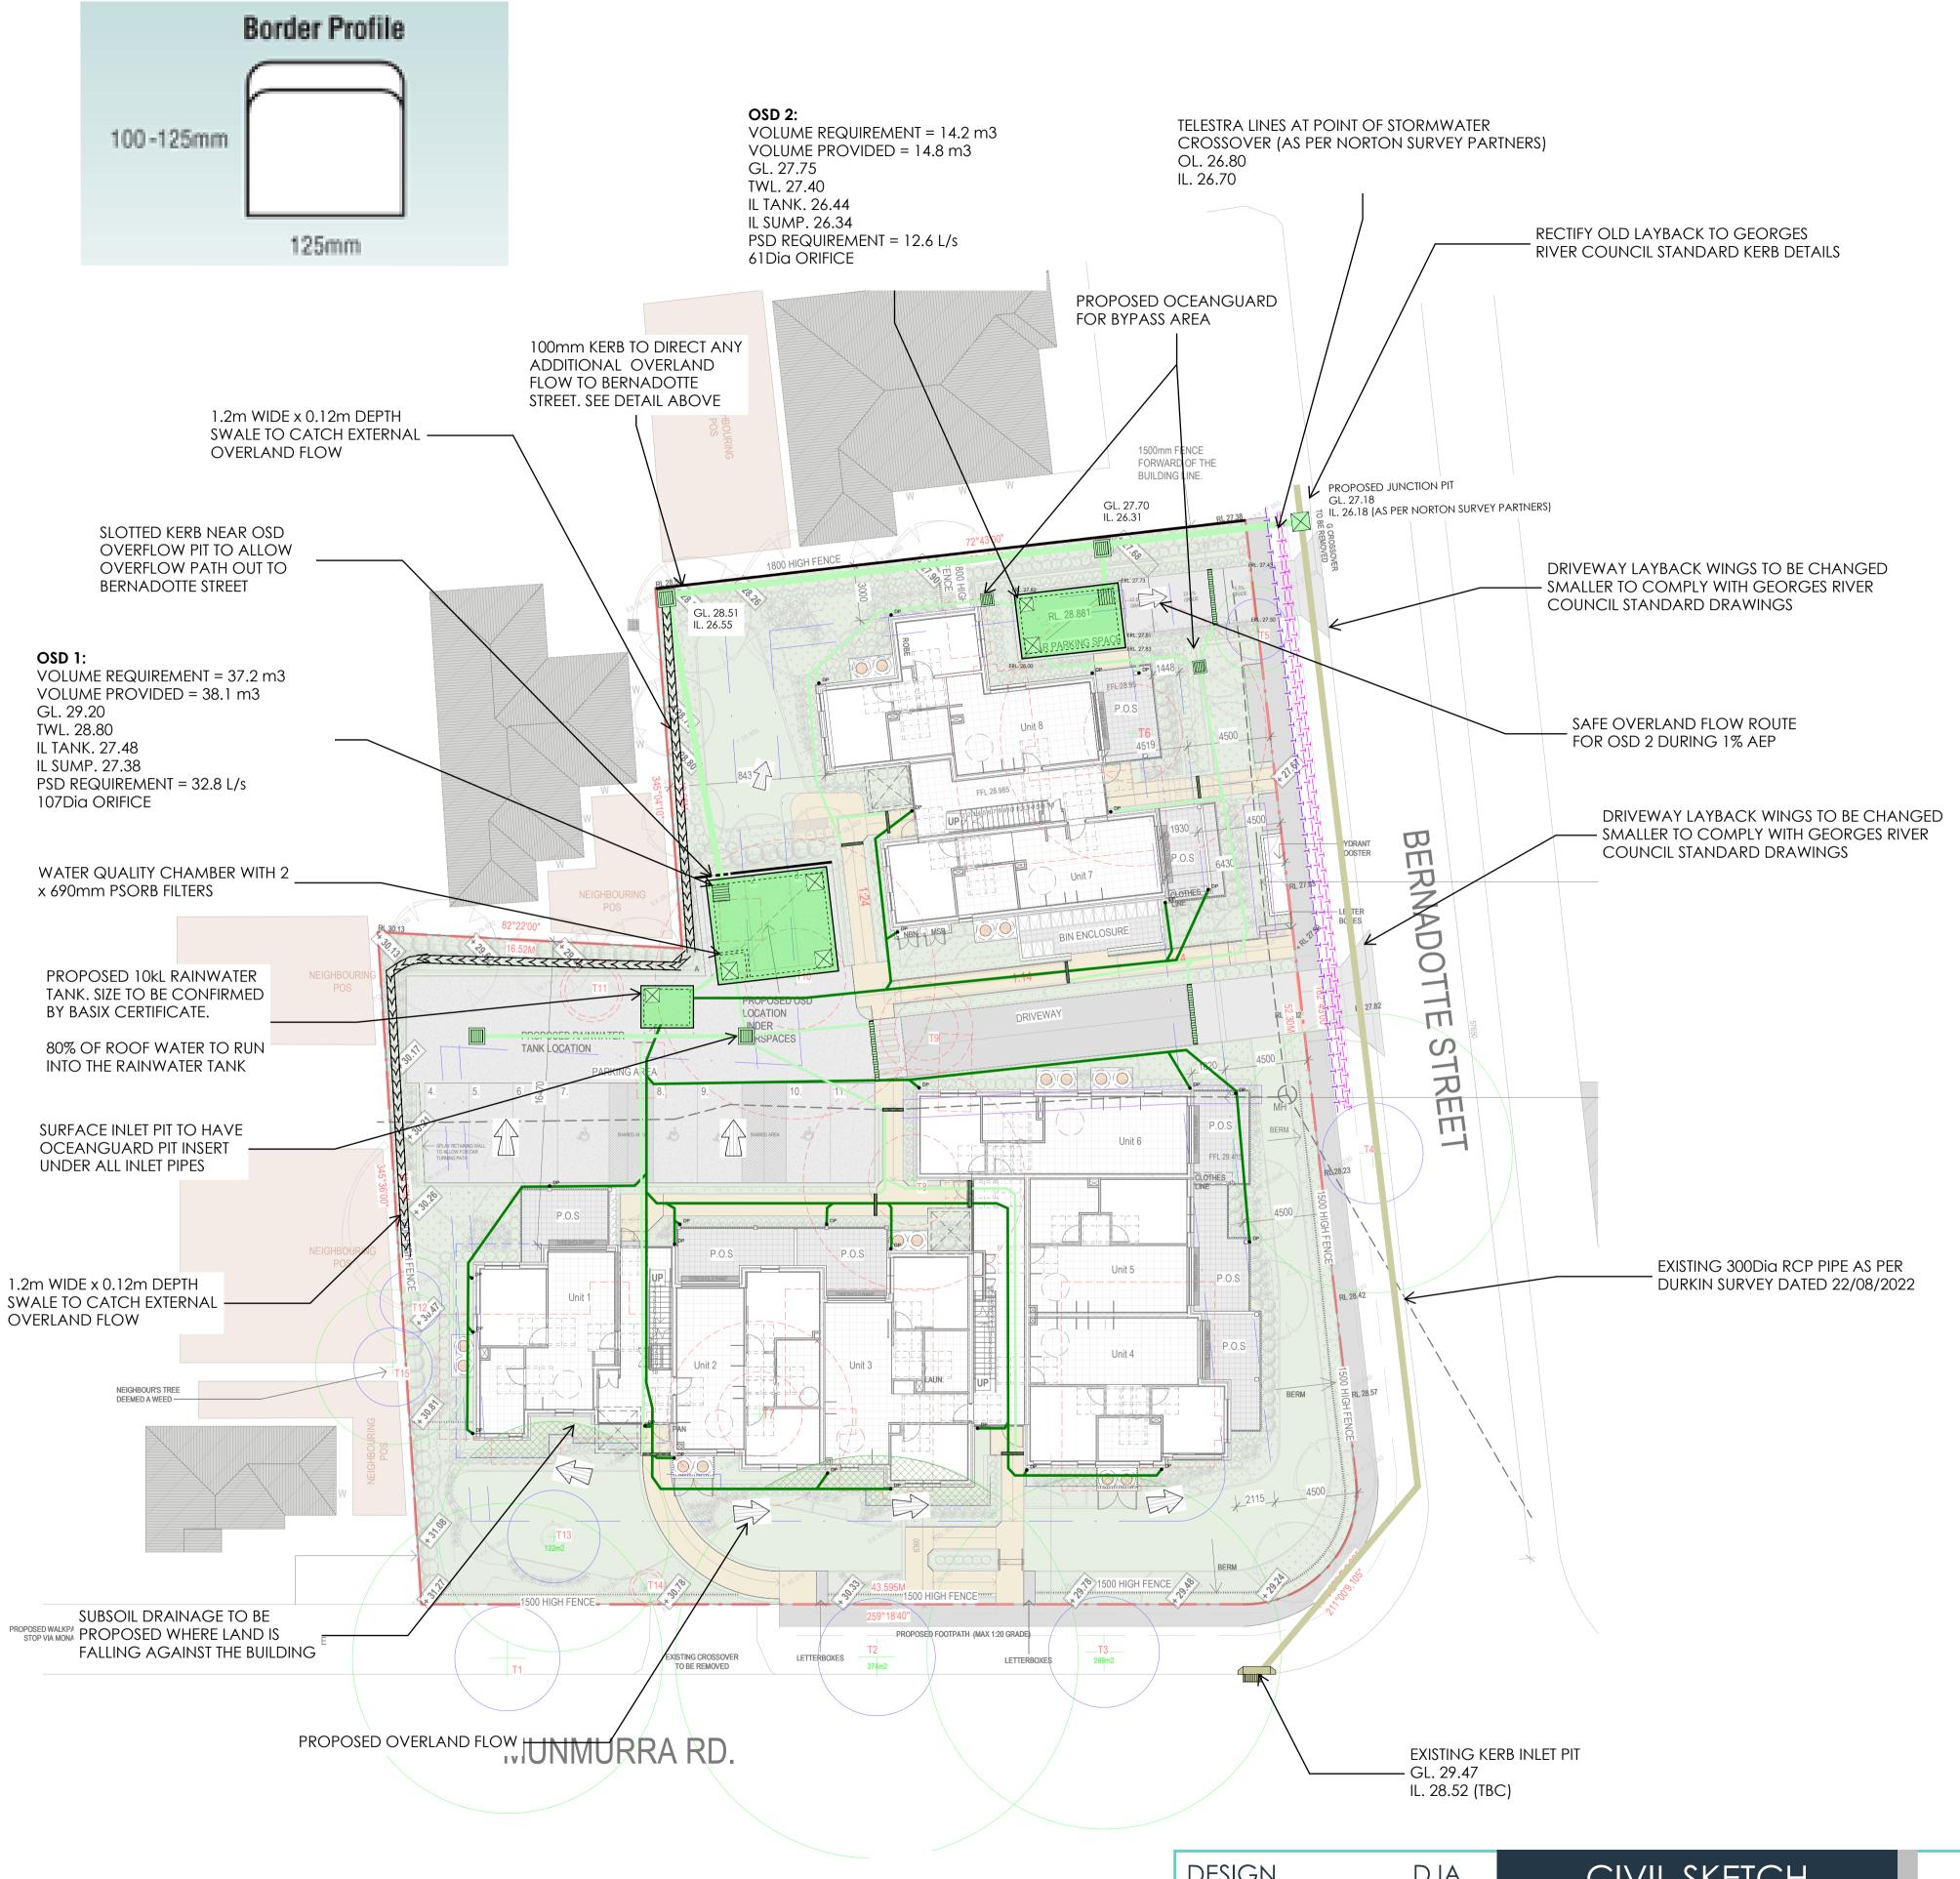







Jones Nicholson Pty Ltd (ABN 51 003 316 032)

DESIGN DJA
DATE 13/06/2024
SIZE A1
SCALE 1:200

This document is issued by PROJECT MGR

CIVIL SKETCH


SITE STORMWATER PLAN Proposed Seniors
Housing Development


10-14 Munmurra Road and 5 Bernadotte St Riverwood NSW 2210

Custance Associates Australia Pty


NO221293 CSK01G



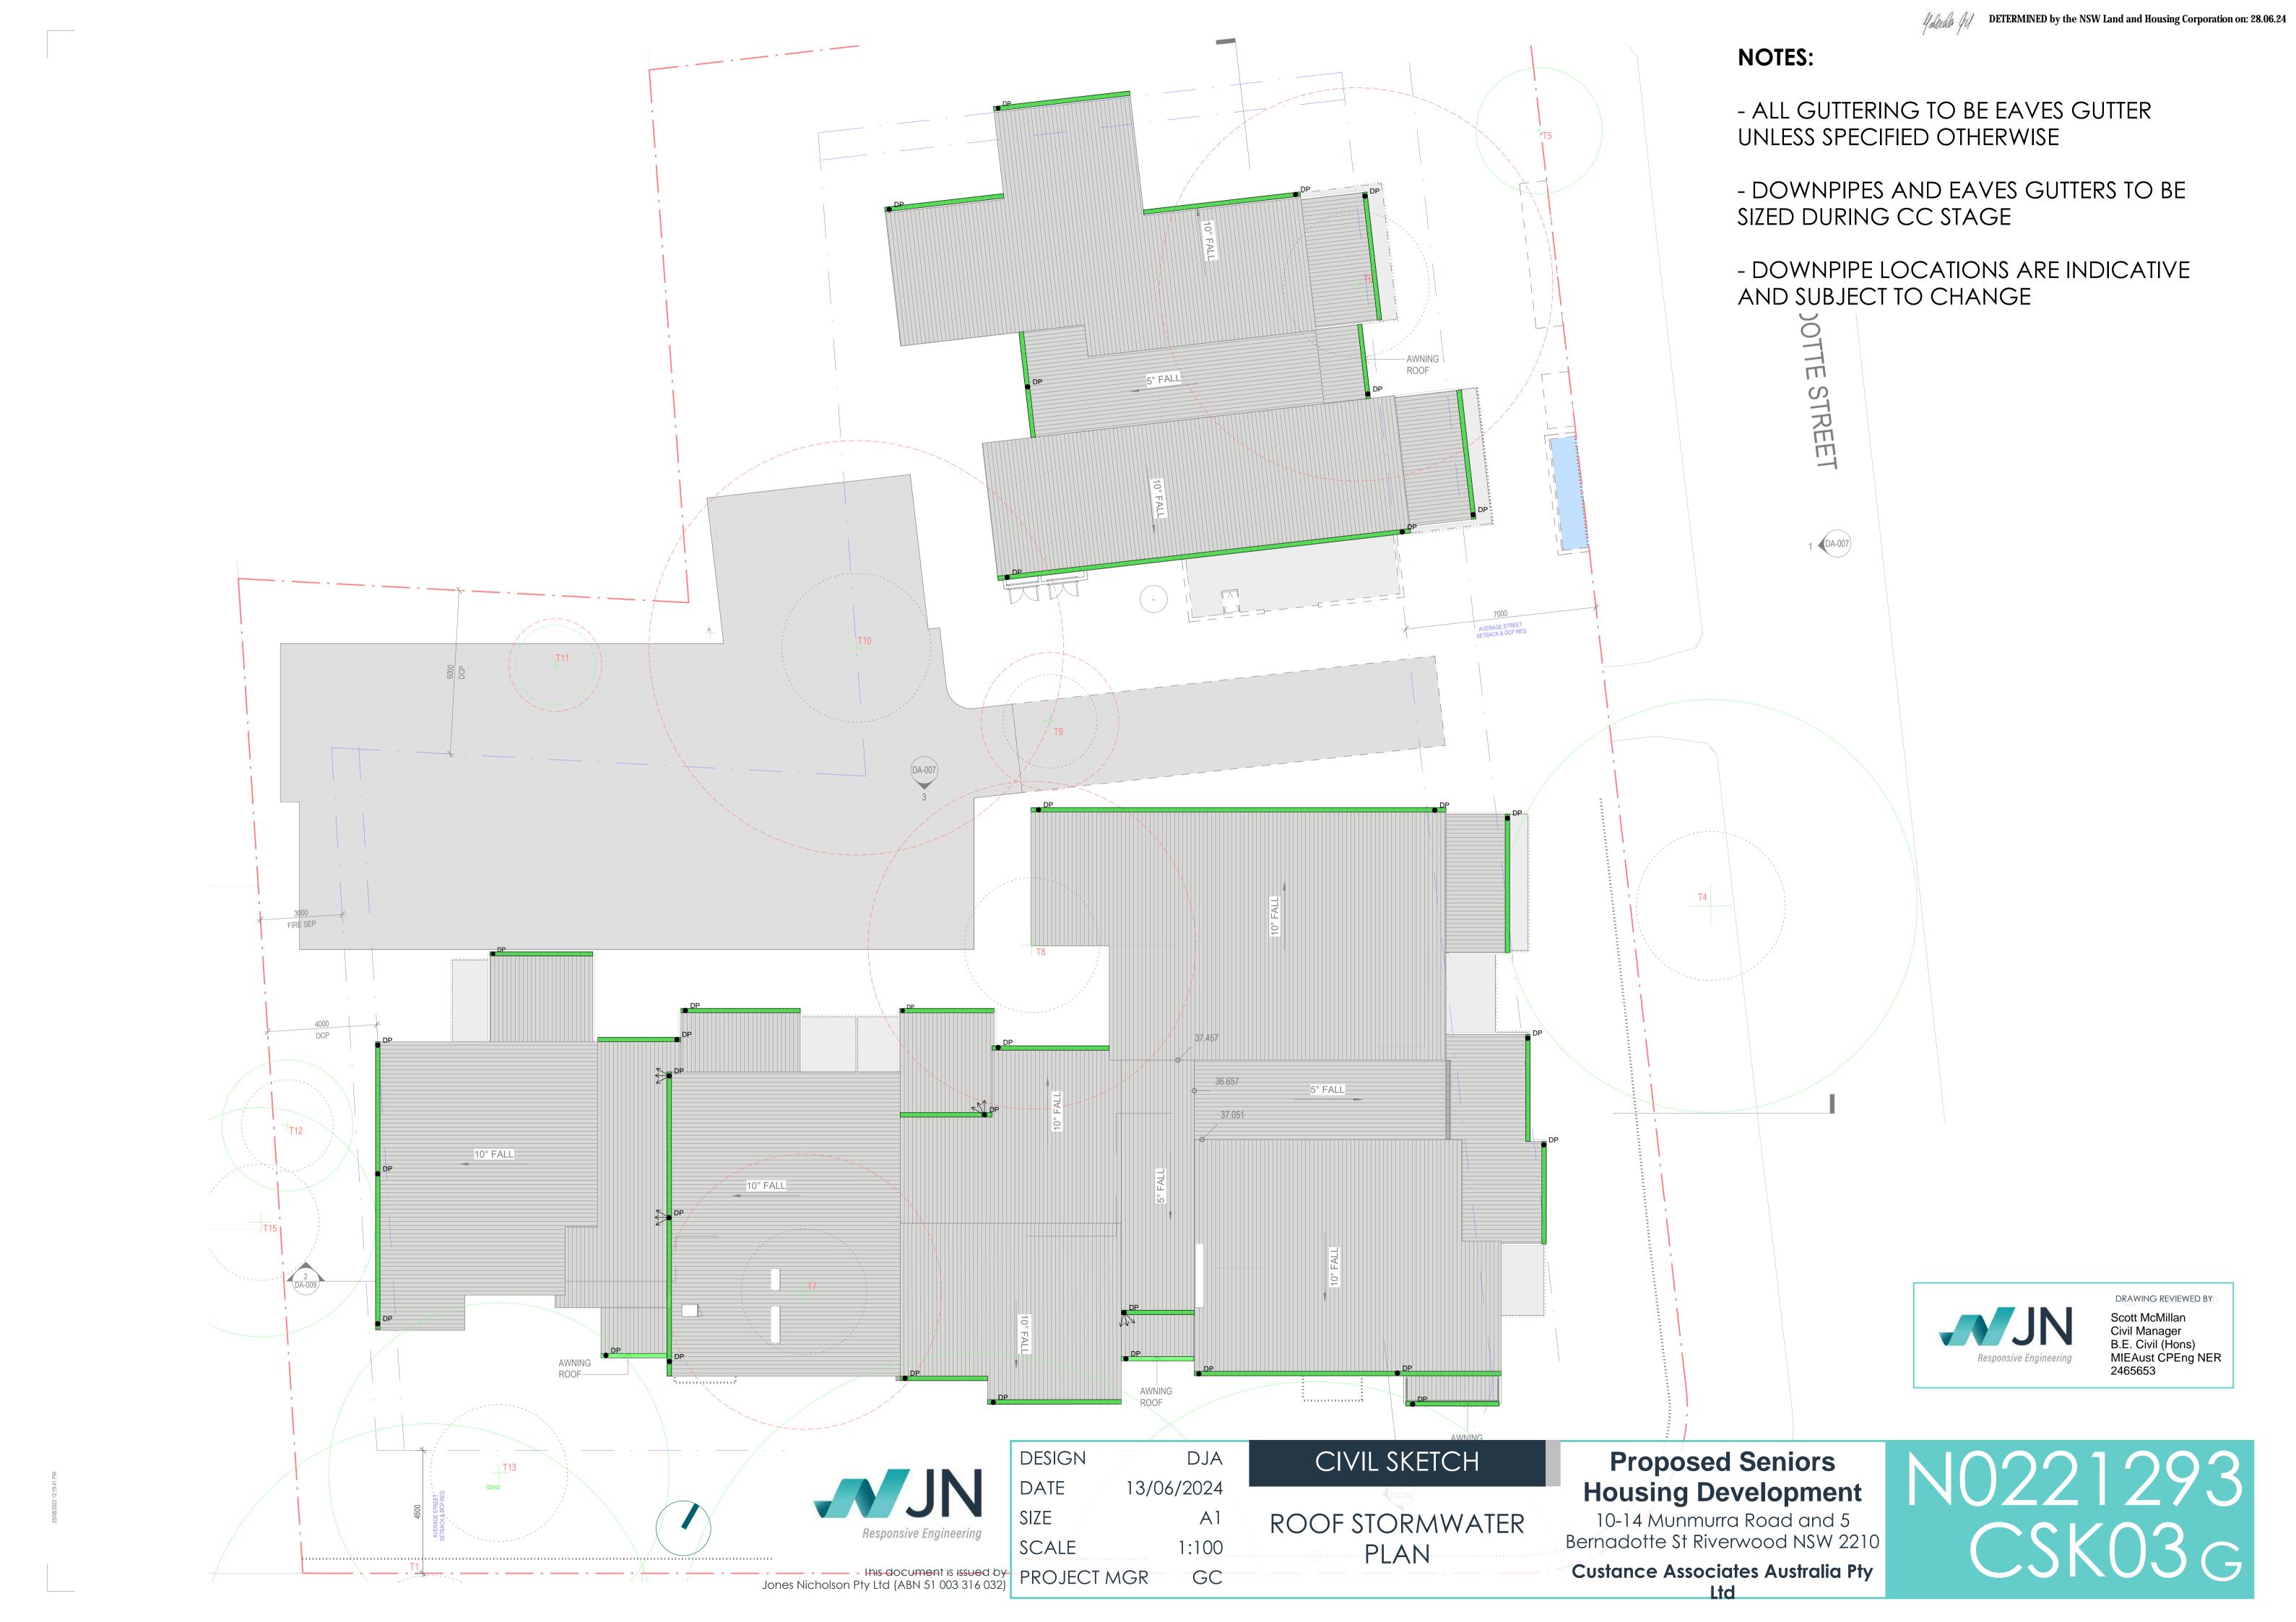


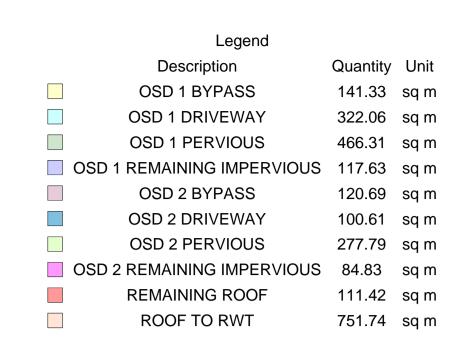



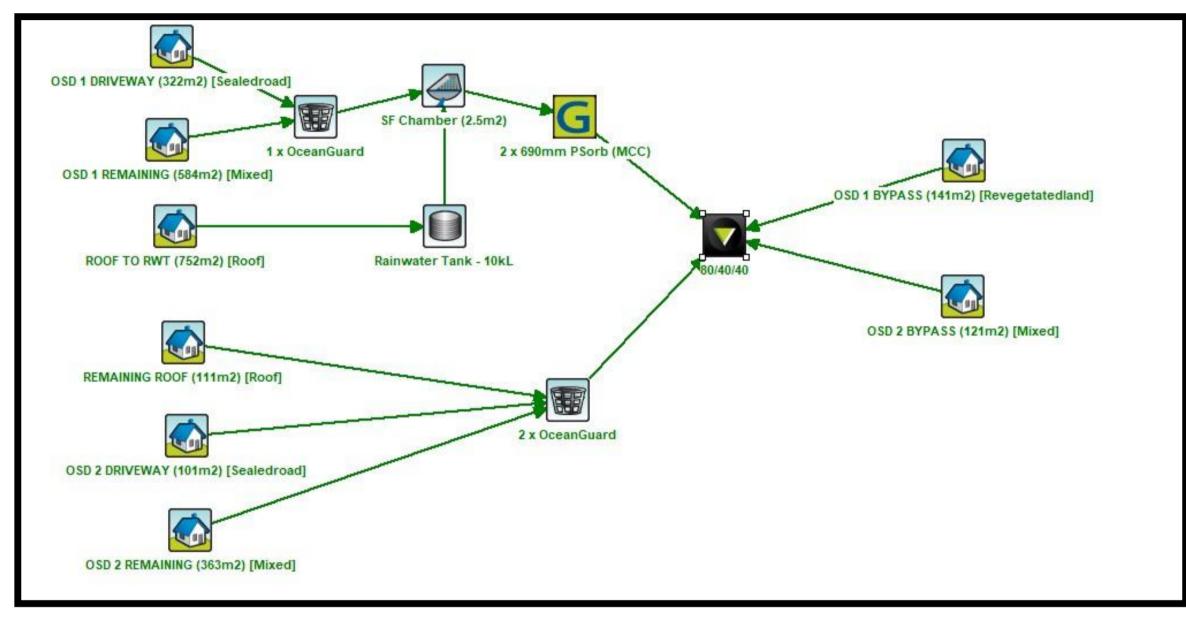

## MUSIC MODEL

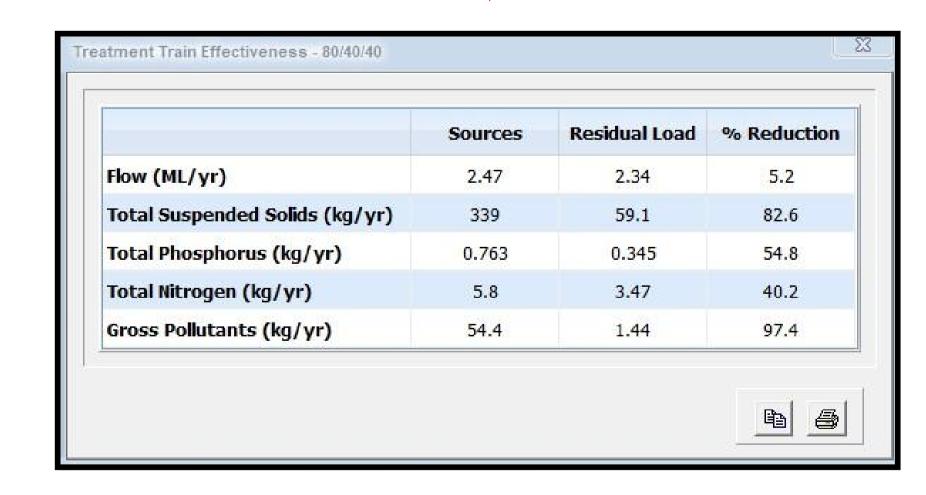

MUSIC RESULTS







DESIGN DJA DATE 13/06/2024 **A**1 SCALE 1:200 Jones Nicholson Pty Ltd (ABN 51 003 316 032)

PROJECT MGR GC

CIVIL SKETCH

WSUD PLAN

## **Proposed Seniors Housing Development**

10-14 Munmurra Road and 5 Bernadotte St Riverwood NSW 2210

**Custance Associates Australia Pty** 

N0221293 CSK04G

# PROPOSED SENIORS DEVELOPMENT


10-14 Munmurra Road & 5 Bernadotte Street, Riverwood NSW 2210

Job No. N0221293


#### **ENVIRONMENTAL SITE MANAGEMENT**

- 1. EROSION & SEDIMENT CONTROLS TO BE INSTALLED IN ACCORDANCE WITH COUNCIL'S SPECIFICATION & THE NSW DEPARTMENT OF HOUSING "BLUE BOOK" - SOILS AND CONSTRUCTION - MANAGING URBAN STORMWATER, 2004. REFER TO THE BLUE BOOK FOR STANDARD DRAWINGS "SD"
- 2. SEDIMENT & EROSION CONTROLS MUST BE IN PLACE PRIOR TO THE COMMENCEMENT OF ANY EARTHWORKS OR DEMOLITION ACTIVITY. THE LOCATION OF SUCH DEVICES IS INDICATIVE ONLY AND FINAL POSITION SHOULD BE DETERMINED ON SITE.
- 3. IT IS THE RESPONSIBILITY OF THE CONTRACTOR TO ENSURE THAT ALL MEASURES ARE TAKEN DURING THE COURSE OF CONSTRUCTION TO PREVENT SEDIMENT EROSION AND POLLUTION OF THE DOWNSTREAM SYSTEM, SUPERVISING ENGINEER SHOULD BE CONTACTED IF IN DOUBT. ALL SEDIMENT CONTROL STRUCTURES TO BE INSPECTED AFTER EACH RAINFALL EVENT FOR STRUCTURAL DAMAGE AND ALL TRAPPED SEDIMENT TO BE REMOVED TO A NOMINATED
- 4. RETAIN ALL EXISTING GRASS COVER WHEREVER POSSIBLE. TOPSOIL FROM ALL AREAS THAT WILL BE DISTURBED TO BE STRIPPED AND STOCKPILED AT THE NOMINATED SITE. A SEDIMENT FENCE TO BE PLACED DOWNHILL OF STOCKPILE.
- 5. AREAS OF SITE REGRADING ARE TO BE COMPLETED PROGRESSIVELY DURING THE WORKS AND STABILISED AS EARLY AS POSSIBLE. THE SUPERVISING ENGINEER MAY DIRECT THE CONTRACTOR TO HAVE AREAS OF DISTURBANCE COMPLETED AND STABILISED DURING THE COURSE OF THE WORKS.
- 6. ALL DISTURBED AREAS ARE TO BE SEEDED & FERTILISED WITHIN 14 DAYS OF EXPOSURE. 7. ALL EXISTING TREES TO BE RETAINED UNLESS SHOWN OTHERWISE ON APPROVED DRAWINGS. TREES RETAINED ARE TO BE PROTECTED WITH A HIGH VISIBILITY FENCE, PLUS FLAGGING TO INDIVIDUAL TREES AS NECESSARY.
- 8. INSTALL TEMPORARY SEDIMENT BARRIERS TO ALL INLET PITS LIKELY TO COLLECT SILT LADEN WATER, UNTIL SURROUNDING AREAS ARE PAVED OR REGRASSED. GRAVEL OR GEOTEXTILE
- INLET FILTERS TO SD6-11 & SD6-12. 9. ALL SILT FENCES & BARRIERS ARE TO BE MAINTAINED IN GOOD ORDER & REGULARLY
- DESILTED DURING THE CONSTRUCTION PERIOD. SILT FENCES TO SD6-8 OR SD6-9. 10. STOCKPILES OF LOOSE MATERIALS SUCH AS SAND, SOIL, GRAVEL MUST BE COVERED WITH GEOTEXTILE SILT FENCE MATERIAL. PLASTIC SHEETING OR MEMBRANE MUST NOT BE USED. SAFETY BARRICADING SHOULD BE USED TO ISOLATE STOCKPILES OF SOLID MATERIALS SUCH AS STEEL REINFORCING, FORMWORK AND SCAFFOLDING.
- 11. WASTE MATERIALS ARE TO BE STOCKPILED OR LOADED INTO SKIP-BINS LOCATED ON SITE AS SHOWN ON PLAN.
- 12. NO MORE THAN 150m OF TRENCHING TO BE OPEN AT ANY ONE TIME. IMMEDIATELY AFTER TRENCH BACKFILLING, PROVIDE SANDBAGS OR SAUSAGE FILTERS ACROSS EACH TRENCH AT MAXIMUM 20m SPACINGS. FILTERS TO REMAIN IN PLACE UNTIL REVEGETATION HAS
- 13. ALL VEHICLES LEAVING THE SITE MUST PASS OVER THE STABILISED SITE ACCESS BALLAST AREA (SIMILAR TO SD6-14) TO SHAKE OFF SITE CLAY AND SOIL. IF NECESSARY WHEELS AND AXLES ARE TO BE HOSED DOWN. BALLAST IS TO BE MAINTAINED & REPLACED AS NECESSARY DURING THE CONSTRUCTION PERIOD.
- 14. THE HEAD CONTRACTOR IS TO INFORM ALL SITE STAFF AND SUB-CONTRACTORS OF THEIR OBLIGATIONS UNDER THE EROSION AND SEDIMENT CONTROL PLAN. 15. ANY SEDIMENT DEPOSITED ON THE PUBLIC WAY, INCLUDING FOOTPATH RESERVE AND ROAD
- SURFACE, IS TO BE REMOVED IMMEDIATELY. 16. PROVIDE BARRIERS AROUND ALL CONSTRUCTION WORKS WITHIN THE FOOTPATH AREA TO
- PROVIDE SAFE ACCESS FOR PEDESTRIANS. 17. CONCRETE PUMPS AND CRANES ARE TO OPERATE FROM WITHIN THE BALLAST ENTRY DRIVEWAY AREA AND ARE NOT TO OPERATE FROM THE PUBLIC ROADWAY UNLESS SPECIFIC COUNCIL PERMISSION IS OBTAINED.
- 18. DELIVERY VEHICLES MUST NOT STAND WITHIN THE PUBLIC ROADWAY FOR MORE THAN 20
- 19. TRUCKS REMOVING EXCAVATED / DEMOLISHED MATERIAL SHOULD TRAVEL ON STABILISED CONSTRUCTION PATHS. MATERIAL TO BE TAKEN TO THE TRUCK TO REDUCE TRUCK MOVEMENT ON SITE. TRUCKS TO BE LIMITED TO SINGLE UNIT HEAVY RIGID VEHICLES. ( NO
- 20. ANY EXCAVATION WORK ADJACENT TO ADJOINING PROPERTIES OR THE PUBLIC ROADWAY IS NOT TO BE COMMENCED UNTIL THE STRUCTURAL ENGINEER IS CONSULTED AND SPECIFIC INSTRUCTIONS RECEIVED FROM THE ENGINEER.
- 21. TOILET FACILITIES MUST BE EITHER A FLUSHING TYPE OR APPROVED PORTABLE CHEMICAL CLOSET. CHEMICAL CLOSETS ARE TO BE MAINTAINED & SERVICED ON A REGULAR BASIS SO THAT OFFENSIVE ODOUR IS NOT EMITTED.
- 22.DURING TRENCH EXCAVATION ALL SPOIL SHALL BE MOUNDED ON THE UPHILL SIDE OF TRENCHES AND PLACEMENT IS TO COMPLY WITH THE SUPERINTENDENTS REQUIREMENT.
- 23.DIVERSION BANKS SHOULD BE CONSTRUCTED BY MOUNDING STRIPPED TOPSOIL (MIN HEIGHT 600mm) WHERE DIRECTED. MATERIAL TO BE RESPREAD ON FOOTWAYS AFTER FINAL
- 24.UNDISTURBED BUFFER ZONE AREAS ARE CLOSED TO ALL TRAFFIC MOVEMENTS UNLESS OTHERWISE NOTED BY THE SUPERINTENDENT AND ACCESS TO THE SEWER OR C.D.L.
- TRENCHING WILL BE AS SHOWN, OR HEAVY PENALTIES MAY BE IMPOSED. 25.TRAFFIC MANAGEMENT MEASURES ARE REQUIRED TO BE IMPLEMENTED AND MAINTAINED DURING CONSTRUCTION, IN ACCORDANCE WITH 'R.T.A. TRAFFIC CONTROL AT WORK SITES Current edition' and as 1742 'manual of uniform traffic control devices
- 26.PEDESTRIAN CONTROL MEASURES ARE REQUIRED TO BE IMPLEMENTED AND MAINTAINED DURING CONSTRUCTION. IN ACCORDANCE WITH AS 1742 'MANUAL OF UNIFORM TRAFFIC

SYMBOL	DESCRIPTION
	PROPOSED BUILDING LINE
	PROPOSED BUILDING ROOF OUTLINE
	PROPRIETARY SILT FENCE
	PROVIDE TEMPORARY CHAIN WIRE FENCING (HOARDING) ALONG THE SITE BOUNDARY
	TEMPORARY STABALISED CONSTRUCTION ENTRY/EXIT. (SHAKER PAD)
	TEMPORARY FILTER TUBE WITH SAFETY BARRICADE TO KERB INLET PITS.
4 4 4	TEMPORARY MASS CONCRETE FOOTPATH CROSSING.
	DIRECTION OF FLOW
	DIVERSION BANK
	SURFACE INLET DRAINAGE PIT WITH SURROUNDING FILTER FABRIC INLET SEDIMENT TRAP OR FILTER TUBES (SANDBAGS)
	TEMPORARY GEOTEXTILE WRAPPED HAY BALES/SAND BAGS
8	SANDBAG SEDIMENT INLET TRAP
00	SANDBAG KERB SEDIMENT TRAP

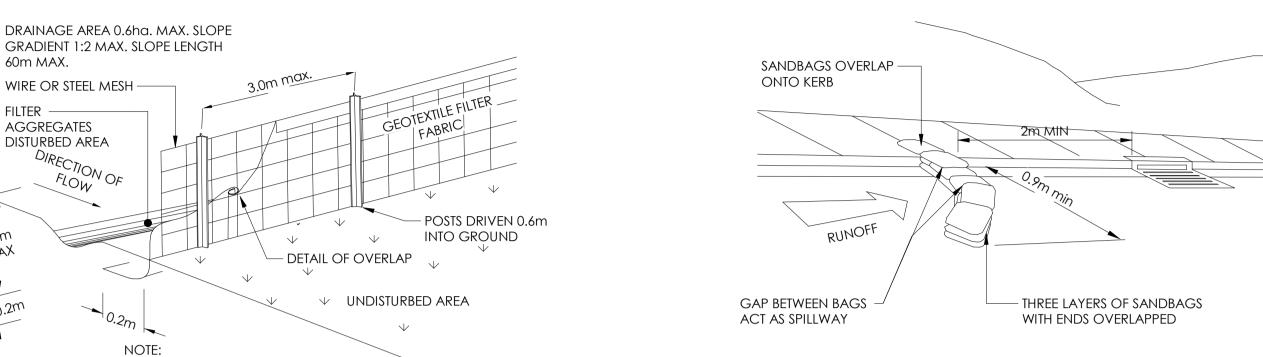


SANDBAG SEDIMENT TRAP DETAIL

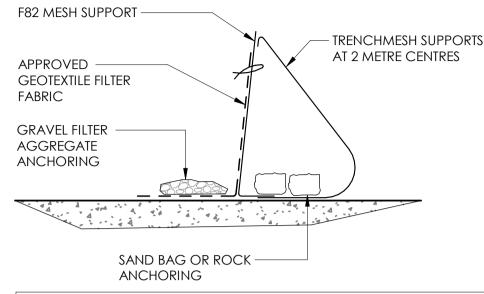



#### **GENERAL CONSTRUCTION NOTES:**

- 1. CONSTRUCT SEDIMENT FENCE AS CLOSE AS POSSIBLE TO PARALLEL TO THE CONTOURS OF THE SITE.
- 2. FIX SELF-SUPPORTING GEOTEXTILE TO UPSLOPE SIDE OF POSTS WITH WIRE TIES OR AS RECOMMENDED BY GEOTEXTILE MANUFACTURER.
- 3. JOIN SECTIONS OF FABRIC AT A SUPPORT WITH A 150mm OVERLAP. 4. REFER TO DETAIL SD 6-9 "BLUE BOOK"

## SEDIMENT FENCE - ALTERNATIVE

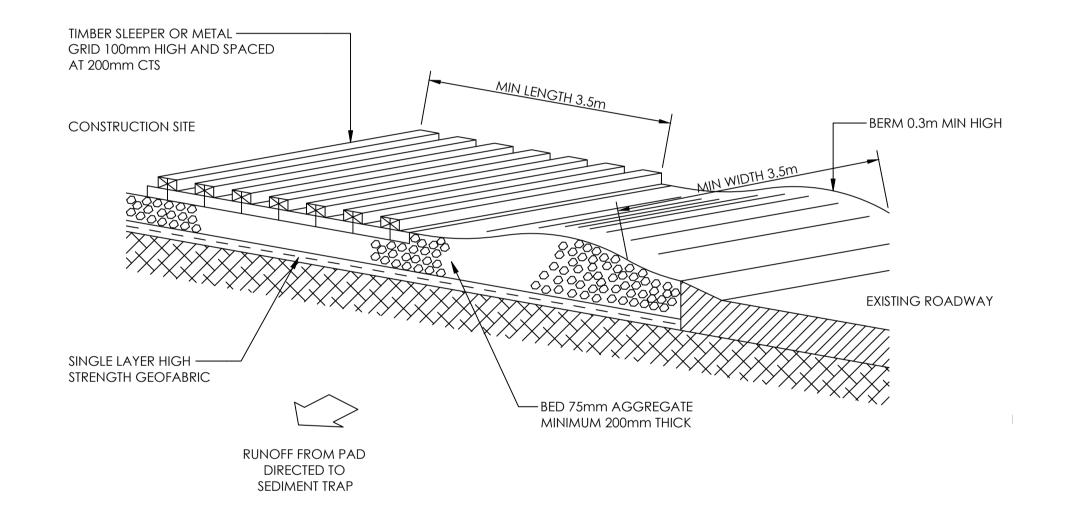

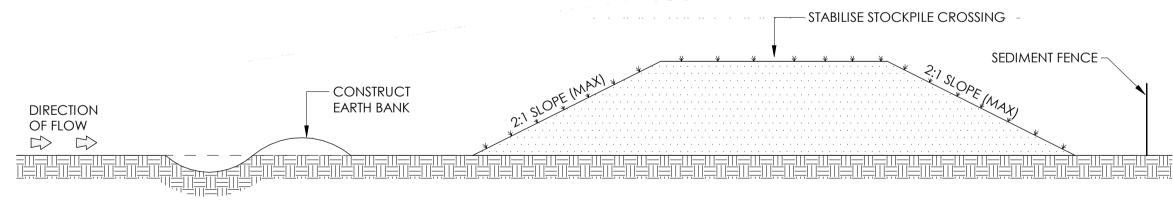

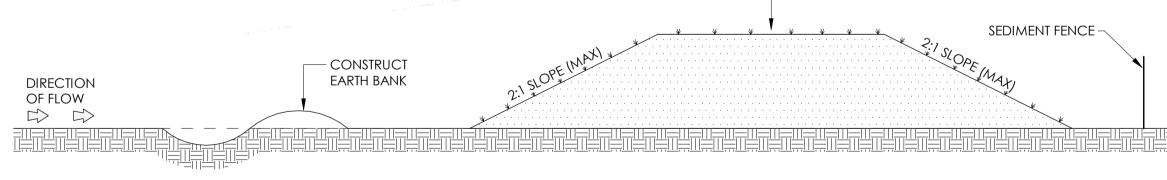


**STOCKPILES** 

#### N.T.S **GENERAL CONSTRUCTION NOTES:** . LOCATE STOCKPILE AT LEAST 5m FROM VEGETATION, CONCENTRATED WATER FLOWS, ROADS AND HAZARD AREAS. 2. CONSTRUCT ON THE CONTOUR AS A LOW FLAT ELONGATED MOUND. B. WHERE THERE IS A SUFFICIENT AREA TOPSOIL STOCKPILES SHALL BE LESS THAN 2m IN HEIGHT. (TO ALLOW AIR VENTILATION FOR FUTURE REUSE)

4. REHABILITATE IN ACCORDANCE WITH THE SWMP/ESCP. 5. CONSTRUCT EARTH BANK ON THE UPSLOPE SIDE TO DIVERT RUN OFF AROUND THE STOCKPILE AND A SEDIMENT FENCE 1m TO 2m DOWNSLOPE OF STOCKPILE.

**STOCKPILES** 

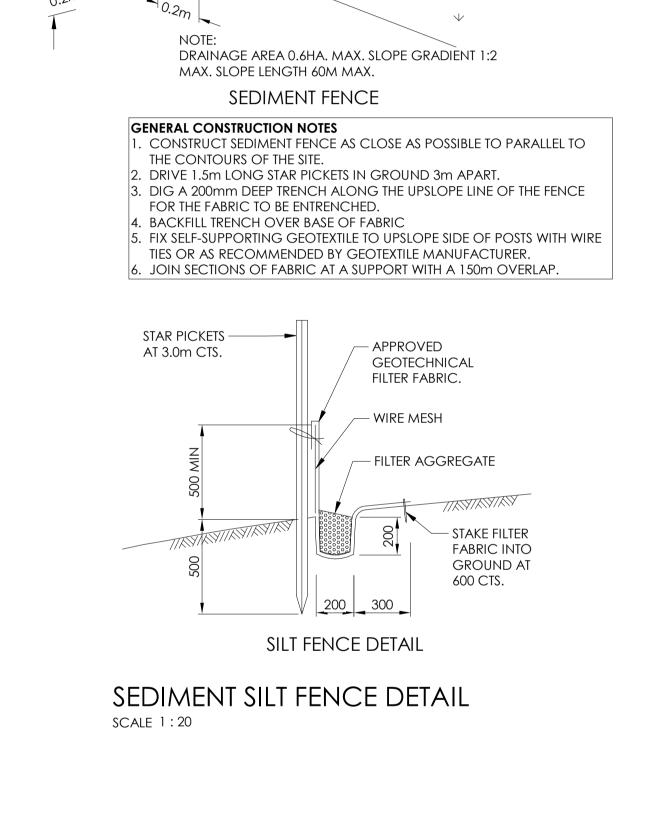

GEOTEXTILE FILTER FABRIC DROP INLET SEDIMENT TRAP DETAIL SCALE 1:20

STAKES

**FILTERED** 

WATER

GEOTEXTILE FILTER



**GEOTEXTILE** FILTER FABRIC

**RUNOFF WATER** 

WITH SEDIMENT

DESIGN DJA DATE 13/06/2024 **A**1 SCALE AS SHOWN PROJECT MGR Jones Nicholson Pty Ltd (ABN 51 003 316 032)

- DROP INLET

WITH GRATE

CIVIL SKETCH ESM SITE PLAN

# **Proposed Senior Development**

10-14 Munmurra Road and 5 Bernadotte St Riverwood NSW 2210

**Custance Associates Australia Pty** 

N0221293







DESIGN DJA DATE 13/06/2024 SIZE **A**1 SCALE 1:200 Jones Nicholson Pty Ltd (ABN 51 003 316 032)

PROJECT MGR GC

CIVIL SKETCH

ESM SITE PLAN

Proposed Senior Development

10-14 Munmurra Road and 5 Bernadotte St Riverwood NSW 2210

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N0221293 ESM2 B